TOWN COUNCIL ACTION ITEM STAFF SUMMARY AUGUST 7, 2019 PLANNING AND ZONING COMMISSION MEETING

DATE: July 31, 2019

AGENDA ITEM NUMBER: 4

ACTION TO BE CONSIDERED: Approval of Resolution PZ 16-19, Series of 2019: A RESOLUTION APPROVING FINAL ARCHITECTURAL PLANS FOR THE DILLON MEDICAL BUILDING PUD DEVELOPMENT PLAN.

TIME FRAME:

- December 5, 2018 Planning and Zoning Commission Public Hearing & recommendation to approve
- December 18, 2018 Town Council First Reading to set the Public Hearing date
- January 15, 2019 Town Council Second Reading and Public Hearing...Approval of PUD by Ordinance.

SUMMARY:

One of the conditions set forth in paragraph 2 of Exhibit B to Ordinance No. 01-19, Series of 2019, approval of a Level IV Development Application for the Dillon Medical Building PUD Development Plan, was as follows:

2. Prior to the issuance of a Building Permit, final architectural floorplans and elevations, architectural materials board, site plans, utility plans, landscape plans, site lighting plans, and building configuration shall be submitted and reviewed by Town staff. The architectural design and renderings shall then be reviewed by the Town's architectural consultant for conformance with the Town of Dillon's architectural standards. The Applicant will be required to pay for the cost of the additional architectural review. The final architectural design and renderings shall then be reviewed and approved by the Town of Dillon Planning and Zoning Commission in a public hearing to be set at a future date.

Please find attached the revised architectural drawings and material boards for this project for the Planning and Zoning Commissions Review.

Also attached is an email from Chris Holzwart from Roth Shepard who performed the second architectural review of the submittal.

ACTION REQUESTED: Motion, Second, Roll Call Vote. Resolutions require the affirmative vote of a majority of the members present.

STAFF MEMBER RESPONSIBLE: Scott O'Brien, Public Works Director

Mountain Lakestyle
Architectural Principles

PRINCIPLES OF FOCUS

Connectivity with the ground

Expression of the <u>public domain</u>

Use of simple and dynamic roof forms with exposed structure and support systems

Expression of the building structure

Use of vertical openings and deep overhanging roofs and awnings

Use of natural materials and color accents

Transparency and layering

Craft and detail

Simple and pragmatic beauty as an expression of functional honesty


TOWN OF DILLON DESIGN GUIDLINES, MARCH 2017




-monolithic materials and color -simple openings, often sporadic based on function -layered massing, often built on hillsides

Modern Reference:


-layering of massing using materials
-allow expansive view out
-contemporary patterning using basic materials
-large overhangs

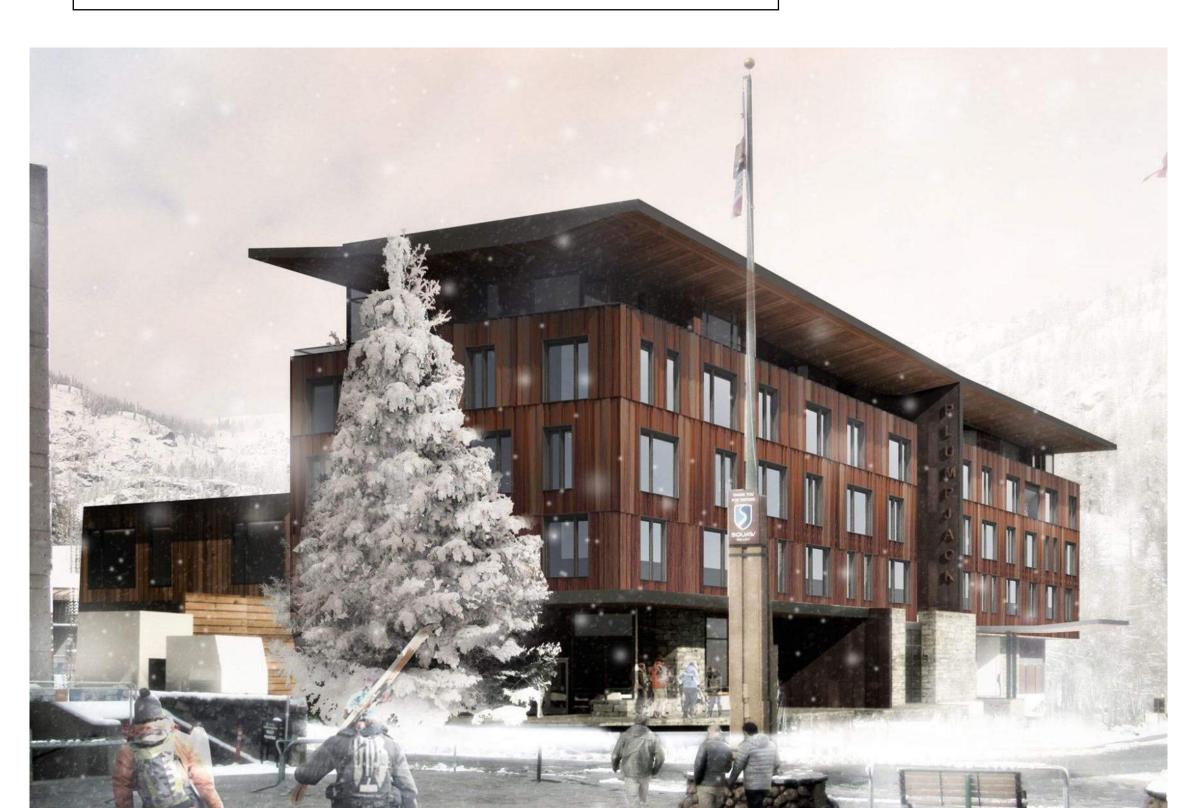

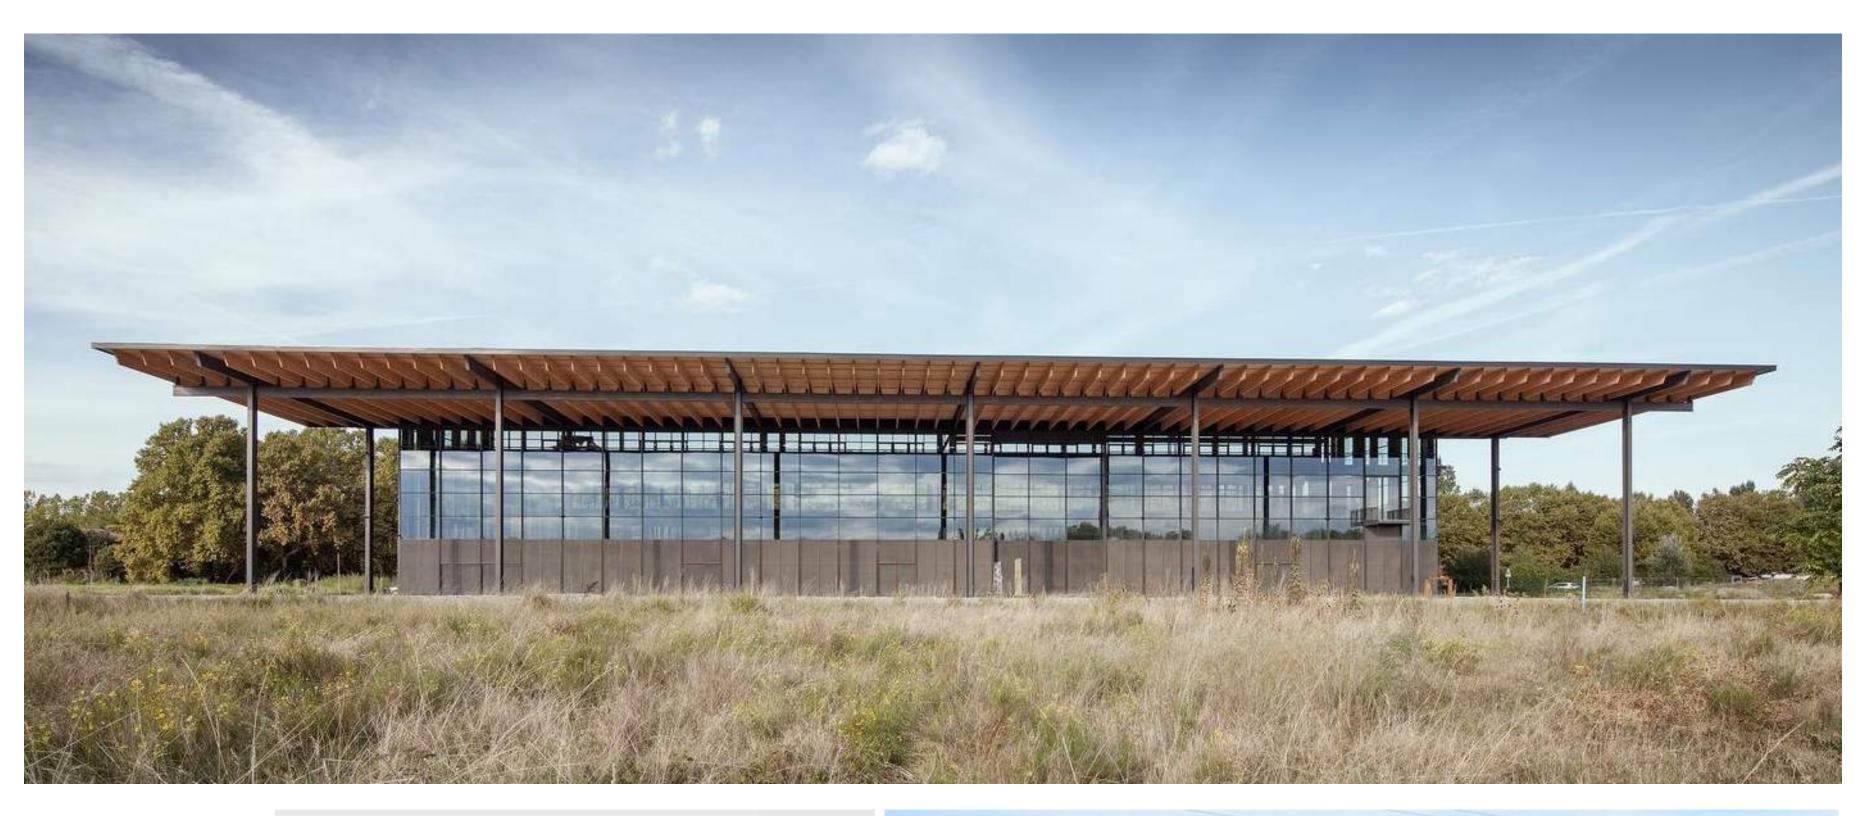





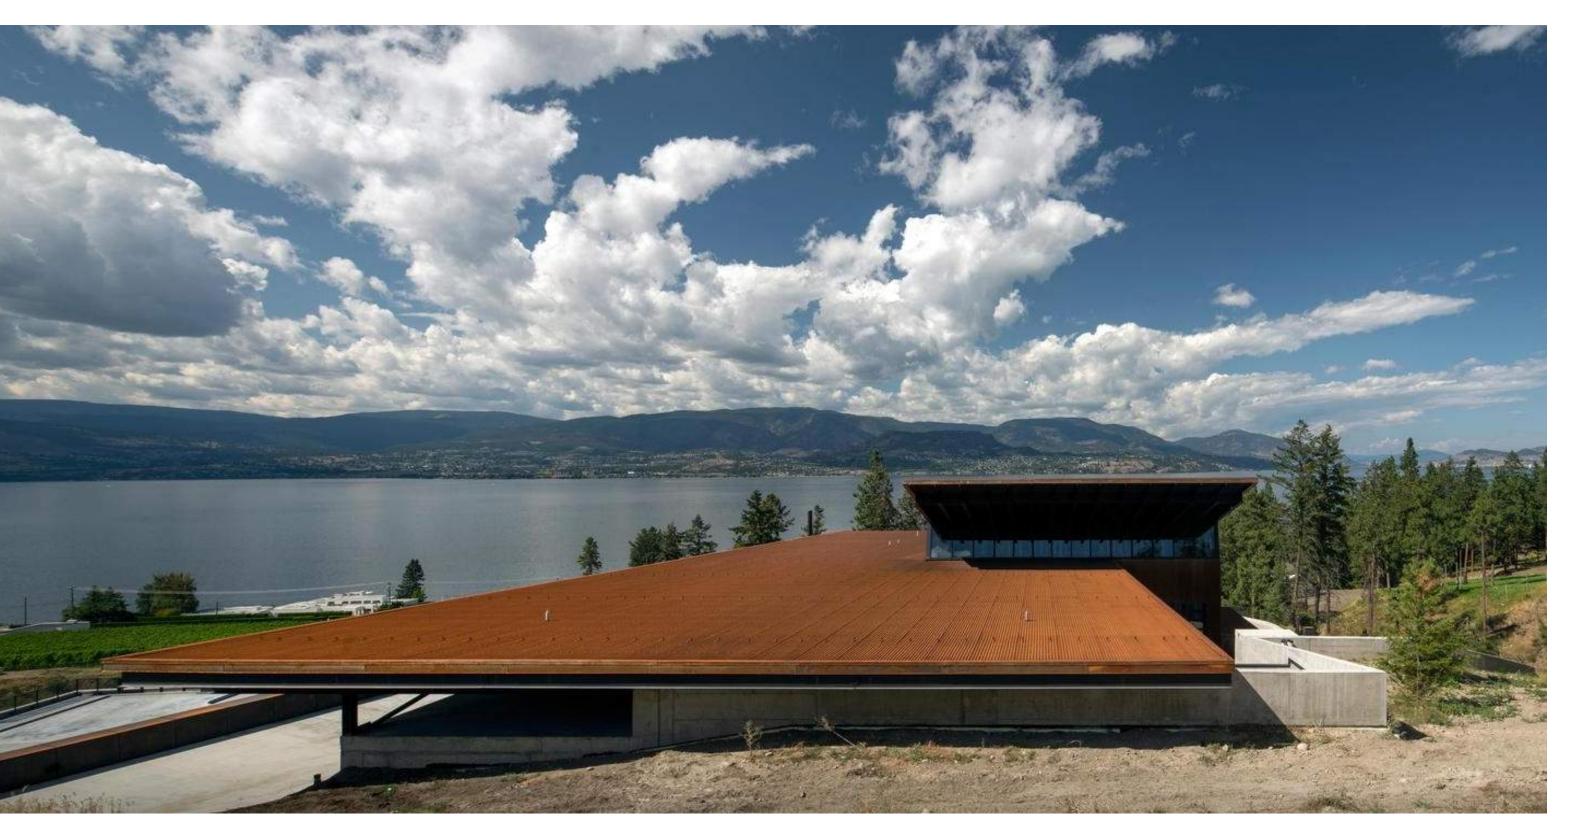



DAVIS
PARTNERSHIP
ARCHITECTS

2901 Blake Street, Suite 100 Denver, CO 80205 303.861.8555

ALEXANDRIA OFFICE 635 South Fairfax Street Alexandria, VA 22314 703.838.8414

DENVER OFFICE

PROGRESS PRINTS

CONSTRUCTION

CONSTRUCTOR

Original Issuance
PUD DEVELOPMENT 11

Revisions

Project Information

VAIL HEALTH - DILLON MEDICAL BUILDING

Sheet Information

Sheet Title:
PRECEDENT
IMAGES


Sheet Number:

A-05

DPA Project: 18917.00

COPYRIGHT 2018 - DAVIS PARTNERSHIP, P.C.

3

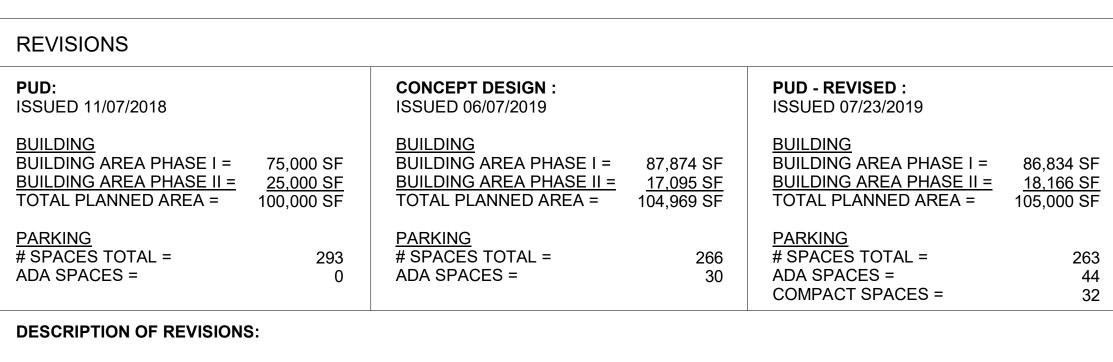

BUILDING

- THE BUILDING AREA ANTICIPATED FOR PHASE I OF CONSTRUCTION INCREASED FOR TWO REASONS-
- 1. THE PHASE II OPERATING ROOMS WILL BE CONSTRUCTED IN PHASE I AND SHELLED FOR FUTURE USE.
- 2. THE EXTERIOR WALL LOCATIONS ON THE EAST SIDE OF LEVELS P1 AND 0 HAVE BEEN SQUARED OFF TO ALLOW FOR THE EASE AND ECONOMY OF CONSTRUCTION. ADDITIONAL AREA WILL BE USED FOR SUPPORT SPACE.


PARKING

- THE NUMBER OF PARKING SPACES HAS REDUCED AS EGRESS STAIRS, AIR INTAKE/EXHAUST LOCATIONS, AND ADA
 PARKING HAS BEEN DEVELOPED.
- THE PROPOSED 263 SPACES ARE NOW PROVIDED TO MEET THE 263 REQUIRED PARKING SPACES FOR A 105,000 SF BUILDING, PER DILLON ZONING REQUIREMENTS.
- 44 ADA PARKING SPACES ARE PROVIDED. 10% OF THE PROVIDED SPACES ARE ALLOCATED FOR ADA BECAUSE OF THE OUTPATIENT FACILITIES IN THE MEDICAL OFFICE BUILDING. ADDITIONAL ADA SPACES HAVE BEEN INCLUDED SO 20% OF PARKING SPACES PROVIDED FOR THE PHYSICAL THERAPY TENANT BE ADA ACCESSIBLE.



Number	Sheet	Issue Date
01 General	,	
00	COVER	07/23/2019
03 Civil		
C-0.1	1- ALTA/NSP LAND TITLE SURVEY	09/20/2018
C-0.2	2- ALTA/NSP LAND TITLE SURVEY	09/20/2018
C-0.3	FINAL PLAT	07/08/2019
C-001	PRELIMINARY SITE PLAN	07/23/2019
C-002	PRELIMINARY UTILITY PLAN	07/23/2019
C-003	PRELIMINARY GRADING PLAN	07/23/2019
04 Landscar	pe	
L-100	LANDSCAPE NOTES	07/23/2019
L-101	LANDSCAPE PLAN	07/23/2019
L-102	SNOW STORAGE PLAN	07/23/2019
L-201 LANDSCAPE DETAILS 07/23/201		07/23/2019
09 Architect	ural	
A-00	ARCHITECTURAL SITE PLAN	07/23/2019
A-01	LEVEL P1	07/23/2019
A-02	LEVEL 0	07/23/2019
A-03	LEVEL 1	07/23/2019
A-04	LEVEL 2	07/23/2019
A-04.1	ROOF PLAN	07/23/2019
A-06	BUILDING STACKING DIAGRAMS	07/23/2019
A-07	SITE SECTIONS/ELEVATIONS	07/23/2019
A-08	PROJECT RENDERINGS	07/23/2019
A-09	PROJECT RENDERINGS	07/23/2019
A-10	PROJECT RENDERINGS	07/23/2019
A-11	PRELIMINARY SIGNAGE PLAN	07/23/2019



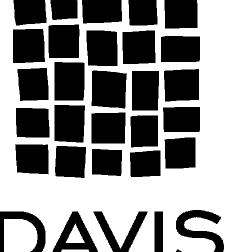

DAVIS
PARTNERSHIP
ARCHITECTS

DENVER OFFICE 2901 Blake Street, Suite 100 Denver, CO 80205 303.861.8555



Issue Date: **JULY 23, 2019**

19905.00

VAIL HEALTH - DILLON MEDICAL BUILDING
DILLON, COLORADO 80435

Original Issuance:

PUD DEVELOPMENT PLAN - REVISED

ALTA/NSPS LAND TITLE SURVEY

SITUATED IN THE SOUTH HALF OF SECTION 7,
TOWNSHIP 5 SOUTH, RANGE 77 WEST OF THE SIXTH PRINCIPAL MERIDIAN,
TOWN OF DILLON, COUNTY OF SUMMIT, STATE OF COLORADO

LEGAL DESCRIPTION (FROM TITLE COMMITMENT NO. 1)

PARCEL A:

BLOCKS 12 AND 13, DILLON RIDGE MARKETPLACE REPLAT D, ACCORDING TO THE PLAT RECORDED MARCH 24, 2004 UNDER RECEPTION NO. 750675, COUNTY OF SUMMIT, STATE OF COLORADO. (NOTE: CORRECT LEGAL SHOULD READ: BLOCKS 12 AND 13, DILLON RIDGE MARKETPLACE REPLAT C, ACCORDING TO THE PLAT RECORDED JANUARY 19, 2000 UNDER RECEPTION NO. 615489, COUNTY OF SUMMIT, STATE OF COLORADO.)

PARCEL B:

"FUTURE PHASE TRACT B", ACCORDING TO THE PLAT FILED FOR (FIRST AMENDMENT TO:) LOOKOUT RIDGE TOWNHOMES PHASE I, RECORDED JUNE 27, 2001 UNDER RECEPTION NO. 655933, COUNTY OF SUMMIT, STATE OF COLORADO: AND MORE PARTICULARLY DESCRIBED AS FOLLOWS:

COMMENCING AT THE NORTHWESTERLY CORNER OF PHASE IV, LOOKOUT RIDGE TOWNHOMES, ACCORDING TO THE FIRST AMENDMENT TO LOOKOUT RIDGE TOWNHOMES PHASE IV RECORDED JUNE 27, 2001 UNDER RECEPTION NO. 65593. IN SAID CLERK AND RECORDER OFFICE, THENCE SOUTH 00 DEGREES 37 MINUTES 05 SECONDS WEST ALONG THE WESTERLY LINE OF SAID PHASE IV, ALSO BEING THE EASTERLY LINE OF DILLON RIDGE MARKETPLACE 392.63 FEET TO THE SOUTHWEST CORNER OF SAID PHASE IV AND THE TRUE POINT OF BEGINNING

THENCE EASTERLY ALONG THE SOUTHERLY BOUNDARY OF SAID PHASE IV, FOR THE FOLLOWING 3

SOUTH 89 DEGREES 20 MINUTES 12 SECONDS EAST A DISTANCE OF 206.07 FEET; 27.25 FEET ALONG THE ARC OF A NON-TANGENT CURVE TO THE LEFT HAVING A CENTRAL ANGLE OF 09 DEGREES 38 MINUTES 18 SECONDS A RADIUS OF 162.00 FEET AND A CHORD WHICH BEARS NORTH 88 DEGREES 27 MINUTES 53 SECONDS EAST 27.22 FEET DISTANT;

61.52 FEET ALONG THE ARC OF A NON-TANGENT CURVE TO THE LEFT HAVING A CENTRAL ANGLE OF 40 DEGREES 31 MINUTES 05 SECONDS A RADIUS OF 87.00 FEET AND A CHORD WHICH BEARS NORTH 61 DEGREES 15 MINUTES 28 SECONDS EAST FEET DISTANT TO A POINT OF THE SOUTHERLY BOUNDARY OF PHASE III, LOOKOUT RIDGE TOWNHOMES, A SUBDIVISION RECORDED MAY 1, 1998

THENCE SOUTH 60 DEGREES 44 MINUTES 17 SECONDS EAST ALONG SAID BOUNDARY A DISTANCE OF 96.87 FEET TO THE SOUTHEASTERLY BOUNDARY OF SAID PHASE I, ALSO BEING THE SOUTH RIGHT OF WAY LINE OF U.S. HIGHWAY NO. 6; THENCE SOUTHWESTERLY ALONG SAID RIGHT OF WAY LINE FOR THE FOLLOWING TWO COURSES:

SOUTH 53 DEGREES 41 MINUTES 26 SECONDS WEST A DISTANCE OF 180.80 FEET;
SOUTH 56 DEGREES 46 MINUTES 59 SECONDS WEST A DISTANCE OF 199.92 FEET TO THE WESTERLY
BOUNDARY OF SAID PHASE I, BEING THE EASTERLY BOUNDARY OF BLOCK 13, DILLON RIDGE
MARKETPLACE, REPLAT C, A SUBDIVISION RECORDED JANUARY 19, 2000 UNDER RECEPTION NO.
615489:

THENCE NORTHERLY ALONG SAID BOUNDARY FOR THE FOLLOWING TWO COURSES;
NORTH 14 DEGREES 50 MINUTES 19 SECONDS WEST A DISTANCE OF 225.90 FEET;
NORTH 00 DEGREES 37 MINUTES 05 SECONDS EAST A DISTANCE OF 18.25 FEET 70 THE POINT OF BEGINNING.

LEGAL DESCRIPTION (FROM TITLE COMMITMENT NO. 2)

BLOCK 14, DILLON RIDGE MARKETPLACE REPLAT D, ACCORDING TO THE PLAT RECORDED MARCH 24, 2004 UNDER RECEPTION NO. 750675, COUNTY OF SUMMIT, STATE OF COLORADO.

(NOTE: CORRECT LEGAL SHOULD READ: BLOCK 14, DILLON RIDGE MARKETPLACE REPLAT C, ACCORDING TO THE PLAT RECORDED JANUARY 19. 2000 UNDER RECEPTION NO. 615489. COUNTY OF SUMMIT. STATE OF COLORADO.)

TITLE COMMITMENT NO. 1 NOTES

OLD REPUBLIC NATIONAL TITLE INSURANCE COMPANY ORDER NO. M20181159-4, WITH AN EFFECTIVE DATE OF 06/28/2018 AT 5:00 P.M. WAS RELIED UPON FOR RECORD INFORMATION REGARDING RIGHTS-OF-WAY, EASEMENTS AND ENCUMBRANCES. THIS SURVEY DOES NOT REPRESENT A TITLE SEARCH BY AZTEC CONSULTANTS, INC. TO DETERMINE OWNERSHIP, RIGHTS-OF-WAY, EASEMENTS OR OTHER MATTERS OF PUBLIC RECORD.

ITEM NUMBERS BELOW REFER TO THOSE ITEMS AS LISTED IN SCHEDULE B — SECTION 2 OF SAID TITLE COMMITMENT.

ITEM NUMBERS 1-7 ARE STANDARD EXCEPTIONS NOT TO BE ADDRESSED AS A PART OF THIS SURVEY.

- 8. RIGHT OF THE PROPRIETOR OF A VEIN OR LODE TO EXTRACT AND REMOVE HIS ORE THEREFROM, SHOULD THE SAME BE FOUND TO PENETRATE OR INTERSECT THE PREMISES HEREBY GRANTED, AND A RIGHT—OF—WAY FOR DITCHES OR CANALS CONSTRUCTED BY THE AUTHORITY OF THE UNITED STATES, AS RESERVED IN UNITED STATES PATENT RECORDED NOVEMBER 23, 1909 IN BOOK 97 AT PAGE 69.

 THE ABOVE DOCUMENT DOES PERTAIN TO THE SUBJECT PARCELS BUT HAS NO PLOTTABLE ELEMENTS.
- 9. EASEMENTS NOTES AND DEDICATIONS AS SHOWN AND RESERVED ON THE PLAT OF DILLON RIDGE MARKETPLACE RECORDED ON MARCH 13, 1997 UNDER RECEPTION NO. 535200. THE AFFECTS OF THE ABOVE PLAT ARE SHOWN HEREON.
- 10. RIGHT—OF—WAY AGREEMENT BETWEEN ROBERT Z. ROUSH AND MYRTH N. ROUSH, GRANTORS, AND CITY AND COUNTY OF DENVER, GRANTEES, AS CONTAINED IN DOCUMENT RECORDED DECEMBER 10, 1964 IN BOOK 174 AT PAGE 988.

 THE RIGHT—OF—WAY DESCRIBED IN THE ABOVE DOCUMENT WAS VACATED BY ITEM 19 AND IS NOT SHOWN
- 11. EASEMENT DEED BETWEEN JOHN AND MARGARET BUMPUS AND THE TOWN OF DILLON AS CONTAINED IN DOCUMENT RECORDED MARCH 6, 1978 UNDER RECEPTION NO. 188543. THE EASEMENT DESCRIBED IN THE ABOVE DOCUMENT IS SHOWN HEREON.
- 12. TERMS, CONDITIONS AND PROVISIONS OF DEVELOPMENT AGREEMENT RECORDED MARCH 20, 1997 UNDER RECEPTION NO. 535496.

 THE ABOVE DOCUMENT DOES PERTAIN TO THE SUBJECT PARCELS BUT HAS NO PLOTTABLE ELEMENTS.
- 13. TERMS, CONDITIONS AND PROVISIONS OF AGREEMENT AMENDED RECORDED JULY 31, 1998 UNDER RECEPTION NO. 571515 AND RERECORDED MARCH 30, 1999 UNDER RECEPTION NO. 591726.

 THE ABOVE DOCUMENTS DO PERTAIN TO THE SUBJECT PARCELS BUT HAVE NO PLOTTABLE ELEMENTS.
- 14. (THIS ITEM WAS INTENTIONALLY DELETED)
- 15. (THIS ITEM WAS INTENTIONALLY DELETED)
- 16. TERMS, CONDITIONS AND PROVISIONS OF IRRIGATION EASEMENT AGREEMENT RECORDED APRIL 26, 2000 AT RECEPTION NO. 621275.

 THE EASEMENT DESCRIBED IN THE ABOVE DOCUMENT IS SHOWN HEREON.
- 17. RESTRICTIVE COVENANTS, WHICH DO NOT CONTAIN A FORFEITURE OR REVERTER CLAUSE, BUT OMITTING ANY COVENANTS OR RESTRICTIONS, IF ANY, BASED UPON RACE, COLOR, RELIGION, SEX, SEXUAL ORIENTATION, FAMILIAL STATUS, MARITAL STATUS, DISABILITY, HANDICAP, NATIONAL ORIGIN, ANCESTRY, OR SOURCE OF INCOME, AS SET FORTH IN APPLICABLE STATE OR FEDERAL LAWS, EXCEPT TO THE EXTENT THAT SAID COVENANT OR RESTRICTION IS PERMITTED BY APPLICABLE LAW, AS CONTAINED IN INSTRUMENT RECORDED APRIL 26, 2000, UNDER

THE ABOVE DOCUMENT DOES PERTAIN TO THE SUBJECT PARCELS BUT HAS NO PLOTTABLE ELEMENTS.

- 18. TERMS, CONDITIONS AND PROVISIONS OF EASEMENT RECORDED OCTOBER 17, 2002 AT RECEPTION NO. 698881.

 THE EASEMENT DESCRIBED IN THE ABOVE DOCUMENT IS SHOWN HEREON.
- 19. EASEMENTS, NOTES, DEDICATIONS AND VACATIONS AS SHOWN ON THE PLAT RECORDED MARCH 24, 2004 UNDER RECEPTION NO. 750675.

 THE AFFECTS OF THE ABOVE PLAT ARE REFLECTED HEREON.
- 20. (THIS ITEM WAS INTENTIONALLY DELETED)
- 21. TERMS, CONDITIONS AND PROVISIONS OF TOWN OF DILLON DEVELOPMENT PERMIT RECORDED NOVEMBER 06, 2000 AT RECEPTION NO. 637518.

 (ITEMS 8 THROUGH 21 AFFECT PARCEL A)

 THE ABOVE DOCUMENT DOES PERTAIN TO THE SUBJECT PARCELS BUT HAS NO PLOTTABLE ELEMENTS.

TITLE COMMITMENT #1 NOTES (CONT.)

- 22. RIGHT OF THE PROPRIETOR OF A VEIN OR LODE TO EXTRACT AND REMOVE HIS ORE THEREFROM, SHOULD THE SAME BE FOUND TO PENETRATE OR INTERSECT THE PREMISES HEREBY GRANTED, AND A RIGHT OF WAY FOR DITCHES OR CANALS CONSTRUCTED BY THE AUTHORITY OF THE UNITED STATES, AS RESERVED IN UNITED STATES PATENT RECORDED JUNE 12, 1915 IN BOOK 104 AT PAGE
 - THE ABOVE DOCUMENT DOES PERTAIN TO THE SUBJECT PARCELS BUT HAS NO PLOTTABLE ELEMENTS.
- 23. EASEMENTS, NOTES AND DEDICATIONS AS SHOWN ON THE PLAT FOR LOOKOUT RIDGE TOWNHOMES RECORDED FEBRUARY 05, 1997 UNDER RECEPTION NO. 533030. THE AFFECTS OF THE ABOVE PLAT ARE SHOWN HEREON.
- 24. RESTRICTIVE COVENANTS, WHICH DO NOT CONTAIN A FORFEITURE OR REVERTER CLAUSE, AS CONTAINED IN INSTRUMENT RECORDED FEBRUARY 05, 1997, UNDER RECEPTION NO. 533029 AND AFFIDAVIT OF CORRECTION RECORDED DECEMBER 12, 2003 UNDER RECEPTION NO. 739967. THE ABOVE DOCUMENTS DO PERTAIN TO THE SUBJECT PARCELS BUT HAVE NO PLOTTABLE ELEMENTS.
- 25. TERMS, CONDITIONS AND PROVISIONS OF CROSS EASEMENT, BUFFER AND MAINTENANCE EASEMENT RECORDED JULY 02, 1997 UNDER RECEPTION NO. 541965 AND AMENDED JUNE 27, 2001 UNDER RECEPTION NO. 655934.

 THE EASEMENT DESCRIBED IN THE DOCUMENTS ABOVE IS SHOWN HEREON BUT DOES NOT FALL WITHIN THE SUBJECT BOUNDARY.
- 26. EASEMENTS, NOTES AND DEDICATIONS AS SHOWN ON THE PLAT FOR LOOKOUT RIDGE TOWNHOMES RECORDED JUNE 2, 2001 UNDER RECEPTION NO. 655933. NOTE: ROADS AS SHOWN ON THE PLAT ARE PRIVATE ROADS THE AFFECTS OF THE ABOVE PLAT ARE SHOWN HEREON.

27. (THIS ITEM WAS INTENTIONALLY DELETED)

(ITEMS 22 THROUGH 27 AFFECT PARCEL B)

TITLE COMMITMENT NO. 2 NOTES

THE AFFECTS OF THE ABOVE PLAT ARE SHOWN HEREON.

OLD REPUBLIC NATIONAL TITLE INSURANCE COMPANY ORDER NO. M20181466-2, WITH AN EFFECTIVE DATE OF 07/26/2018 AT 5:00 P.M. WAS RELIED UPON FOR RECORD INFORMATION REGARDING RIGHTS-OF-WAY, EASEMENTS AND ENCUMBRANCES. THIS SURVEY DOES NOT REPRESENT A TITLE SEARCH BY AZTEC CONSULTANTS, INC. TO DETERMINE OWNERSHIP, RIGHTS-OF-WAY, EASEMENTS OR OTHER MATTERS OF PUBLIC RECORD.

ITEM NUMBERS BELOW REFER TO THOSE ITEMS AS LISTED IN SCHEDULE B — SECTION 2 OF SAID TITLE COMMITMENT.

ITEM NUMBERS 1-7 ARE STANDARD EXCEPTIONS NOT TO BE ADDRESSED AS A PART OF THIS SURVEY.

- 8. RIGHT OF THE PROPRIETOR OF A VEIN OR LODE TO EXTRACT AND REMOVE HIS ORE THEREFROM, SHOULD THE SAME BE FOUND TO PENETRATE OR INTERSECT THE PREMISES HEREBY GRANTED, AND A RIGHT—OF—WAY FOR DITCHES OR CANALS CONSTRUCTED BY THE AUTHORITY OF THE UNITED STATES, AS RESERVED IN UNITED STATES PATENT RECORDED NOVEMBER 23, 1909 IN BOOK 97 AT PAGE 69.

 THE ABOVE DOCUMENT DOES PERTAIN TO THE SUBJECT PARCELS BUT HAS NO PLOTTABLE ELEMENTS.
- 9. EASEMENTS NOTES AND DEDICATIONS AS SHOWN AND RESERVED ON THE PLAT OF DILLON RIDGE MARKETPLACE RECORDED ON MARCH 13, 1997 UNDER RECEPTION NO. 535200 AND NOVEMBER 19, 2000 UNDER RECEPTION NO. 615489.
- 10. RIGHT-OF-WAY AGREEMENT BETWEEN ROBERT Z. ROUSH AND MYRTH N. ROUSH, GRANTORS, AND CITY AND COUNTY OF DENVER, GRANTEES, AS CONTAINED IN DOCUMENT RECORDED DECEMBER 10, 1964 IN BOOK 174 AT PAGE 988.

 THE RIGHT-OF-WAY DESCRIBED IN THE ABOVE DOCUMENT WAS VACATED BY ITEM 15 AND IS NOT SHOWN
- 11. EASEMENT DEED BETWEEN JOHN AND MARGARET BUMPUS AND THE TOWN OF DILLON AS CONTAINED IN DOCUMENT RECORDED MARCH 6, 1978 UNDER RECEPTION NO. 188543. THE EASEMENT DESCRIBED IN THE ABOVE DOCUMENT IS SHOWN HEREON.
- 12. TERMS, CONDITIONS AND PROVISIONS OF DEVELOPMENT AGREEMENT RECORDED MARCH 20, 1997 UNDER RECEPTION NO. 535496.

 THE ABOVE DOCUMENT DOES PERTAIN TO THE SUBJECT PARCELS BUT HAS NO PLOTTABLE ELEMENTS.
- 13. TERMS, CONDITIONS AND PROVISIONS OF AGREEMENT AMENDED RECORDED JULY 31, 1998 UNDER RECEPTION NO. 571515 AND RERECORDED MARCH 30, 1999 UNDER RECEPTION NO. 591726.

 THE ABOVE DOCUMENTS DO PERTAIN TO THE SUBJECT PARCELS BUT HAVE NO PLOTTABLE ELEMENTS.
- 14. TERMS, CONDITIONS AND PROVISIONS OF IRRIGATION EASEMENT AGREEMENT RECORDED APRIL 26, 2000 AT RECEPTION NO. 621275.

 THE EASEMENT DESCRIBED IN THE ABOVE DOCUMENT IS SHOWN HEREON.
- 15. EASEMENTS, NOTES, DEDICATIONS AND VACATIONS AS SHOWN ON THE PLAT RECORDED MARCH 24, 2004 UNDER RECEPTION NO. 750675.

 THE AFFECTS OF THE ABOVE PLAT ARE REFLECTED HEREON.

BASIS OF BEARINGS


THE EAST LINE OF BLOCK 14, DILLON RIDGE MARKETPLACE REPLAT C, HAVING A PLATTED BEARING OF NORTH 00°40'41" EAST.

BENCHMARK

NGS E 450 (AZTEC # 403). RECOVERED 3.25" BRASS CAP IN A BOULDER, LOCATED ON THE SOUTH SIDE OF I-70 AND NORTH SIDE OF A CREEK ACCESSIBLE FROM WHERE LITTLE BEAVER TRAIL TURNS SOUTH APPROXIMATELY 0.8 OF MILE EAST OF GRAND ARMY OF THE REPUBLIC HWY AND 230 FEET +/- NORTH OF STRAIGHT CREEK DRIVE. ELEVATION = 8942.52 (NAVD 88).

FLOOD ZONE

THE SUBJECT PROPERTY SHOWN HEREIN LIES WITHIN ZONE X, AREAS DETERMINED TO BE OUTSIDE THE 0.2% ANNUAL CHANCE FLOODPLAIN, PER FEDERAL EMERGENCY MANAGEMENT AGENCY FLOOD INSURANCE RATE MAP COMMUNITY PANEL NO. 08117C0243E, MAP REVISED NOVEMBER 16, 2011.

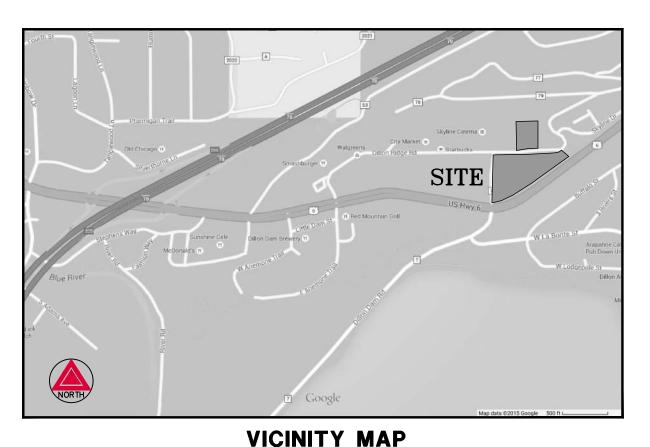

N.

GENERAL NOTES

- 1. THE FIELD WORK FOR THIS SURVEY WAS PERFORMED BY AN AZTEC CONSULTANTS, INC. SURVEY CREW AND COMPLETED ON SEPTEMBER 13, 2018.
- 2. PER C.R.S. 38-51-106, "ALL LINEAL UNITS DEPICTED ON THIS LAND SURVEY PLAT ARE U.S. SURVEY FEET. ONE METER EQUALS 39.37/12 U.S. SURVEY FEET, EXACTLY ACCORDING TO THE NATIONAL INSTITUTE OF STANDARDS AND TECHNOLOGY."
- 3. AS TO TABLE A ITEM NO. 2: THERE WERE NO POSTED ADDRESSES ON THE SUBJECT PARCELS.
- 4. AS TO TABLE A ITEM NO. 4: THE SURVEYED PARCEL CONTAINS A TOTAL OF 5.909 ACRES OR 257,406 SQUARE FEET, MORE OR LESS.
- 5. AS TO TABLE A ITEM NO. 11: THIS SURVEY DOES NOT CERTIFY TO SUBSURFACE FEATURES, IMPROVEMENTS, UTILITIES OR BURIED LINES OF ANY TYPE, LOCATION DEPICTED HEREON ARE DERIVED FROM FIELD SURVEY OF UTILITY FLAGGING / PAINT MARKING, PERFORMED BY AZTEC SURVEY AND LOCATING ON SEPTEMBER 12, 2018.
- 6. AS TO TABLE A ITEM NO. 16: THERE WAS NO OBSERVED EVIDENCE OF CURRENT EARTH MOVING WORK, BUILDING CONSTRUCTION OR BUILDING ADDITIONS AT THE TIME OF THIS SURVEY.
- 7. AS TO TABLE A ITEM NO. 18: NO INFORMATION WAS MADE AVAILABLE OR OBSERVED DURING THE SURVEY RELATING TO THE DELINEATION OF WETLANDS.
- 8. THE SUBJECT PARCELS DO NOT HAVE DIRECT PHYSICAL ACCESS (I.E. CURB CUTS, DRIVEWAYS) TO DILLON DAM ROAD NORTH AND DILLON RIDGE ROAD, BOTH DEDICATED PUBLIC STREETS. THE SUBJECT PARCELS DO HAVE DIRECT PHYSICAL ACCESS TO US HIGHWAY 6, A DEDICATED PUBLIC STREET.
- 9. THE ACCOMPANYING SURVEY WAS MADE ON THE GROUND AND CORRECTLY SHOWS THE LOCATION OF ALL BUILDINGS, STRUCTURES AND OTHER IMPROVEMENTS SITUATED ON THE ABOVE PREMISES; THERE ARE NO VISIBLE ENCROACHMENTS ON THE SUBJECT PROPERTY OR UPON ADJACENT LAND ABUTTING SAID PROPERTY EXCEPT AS SHOWN HEREON AND WAS MADE IN ACCORDANCE WITH LAWS AND/OR MINIMUM STANDARDS OF THE STATE OF COLORADO.
- 10. ANY PERSON WHO KNOWINGLY REMOVES, ALTERS OR DEFACES ANY PUBLIC LAND SURVEY MONUMENT OR ACCESSORY COMMITS A CLASS TWO (2) MISDEMEANOR PURSUANT TO STATE STATUTE 18-4-508, C.R.S.

SURVEYOR'S STATEMENT

TO: DILLON RIDGE INVESTMENTS, LLC, A COLORADO LIMITED LIABILITY COMPANY
DILLON RIDGE MARKETPLACE III LLC, A COLORADO LIMITED LIABILITY COMPANY
TEN MILE HOLDINGS, LLC, A COLORADO LIMITED LIABILITY COMPANY
OLD REPUBLIC NATIONAL TITLE INSURANCE COMPANY
LAND TITLE GUARANTEE COMPANY OF SUMMIT COUNTY

THIS IS TO CERTIFY THAT THIS MAP OR PLAT AND THE SURVEY ON WHICH IT IS BASED WERE MADE IN ACCORDANCE WITH THE 2016 MINIMUM STANDARD DETAIL REQUIREMENTS FOR ALTA/NSPS LAND TITLE SURVEYS, JOINTLY ESTABLISHED AND ADOPTED BY ALTA AND NSPS, AND INCLUDES ITEMS 1—5, 8, 11, 13, 16 AND 18 OF TABLE A THEREOF. THE FIELD WORK WAS COMPLETED ON SEPTEMBER 13, 2018.

DATE OF PLAT OR MAP: 9/21/18

JAMES E. LYNCH, PLS NO. 37933 COLORADO LICENSED PROFESSIONAL LAND SURVEYOR FOR AND ON BEHALF OF AZTEC CONSULTANTS, INC.



NOTICE: ACCORDING TO COLORADO LAW, YOU MUST COMMENCE ANY LEGAL ACTION BASED UPON ANY DEFECT IN THIS SURVEY WITHIN THREE YEARS AFTER YOU FIRST DISCOVER SUCH DEFECT. IN NO EVENT, MAY ANY ACTION BASED UPON ANY DEFECT IN THIS SURVEY BE COMMENCED MORE THAN TEN YEARS FROM THE DATE OF THE CERTIFICATION SHOWN HEREON.

NOTICE: PER THE STATE OF COLORADO BOARD OF LICENSURE FOR ARCHITECTS, PROFESSIONAL ENGINEERS, AND PROFESSIONAL LAND SURVEYORS RULE 6.2.2 THE WORD "CERTIFY" AS USED HEREON MEANS AN EXPRESSION OF PROFESSIONAL OPINION AND DOES NOT CONSTITUTE A WARRANTY OR GUARANTEE, EXPRESSED OR IMPLIED. THE SURVEY REPRESENTED HEREON HAS BEEN PERFORMED BY ME OR UNDER MY DIRECT SUPERVISION IN ACCORDANCE WITH APPLICABLE STANDARDS OF PRACTICE AND IS BASED UPON MY KNOWLEDGE, INFORMATION AND BELIEF.

COUNTY CLERK AND RECORDER'S CERTIFICATE

THIS ALTA WAS FILED FOR RECORD IN THE OFFICE OF THE COUNTY CLERK AND RECORDER OF SUMMIT COUNTY AT _____M. ON THE ____ DAY OF _____, 20__, RECEPTION NO._____.

SUMMIT COUNTY CLERK AND RECORDER

BY: _____

it Mineral Ave., Suite 1

n, Colorado 80122
(303) 713-1898
13) 713-1897
tecconsultants.com

DATE BY REVISION DESCRIPTION

300 East Miner:
Littleton, Color Dittleton, Color Phone: (303) 71.
Fax: (303) 713-1 www.aztecconsu

ADO ADO

PS LAND TITLE SUR
7, T5S, R77W, 6TH
COUNTY, COLORAI

PREPARE FOR
DITHEBY'S INTERNATIONAL REALTY
PO BOX 2619, BRECKENRIDGE, CO.

SUMMIT SOFT

SHEET

1
2 SHEETS

137018-01 OB NO.

ALTA/NSPS LAND TITLE SURVEY SITUATED IN THE SOUTH HALF OF SECTION 7, TOWNSHIP 5 SOUTH, RANGE 77 WEST OF THE SIXTH PRINCIPAL MERIDIAN, TOWN OF DILLON, COUNTY OF SUMMIT, STATE OF COLORADO FIRST AMENDMENT LOOKOUT RIDGE TOWNHOMES REC.# 655933

DILLON RIDGE INVESTMENTS LLC

N77°51'32"E

TRACKING -

41.11'(R)

PARCEL A

N64°33'40"W 📉

35.34'(R)

TC_NQ. 1

DILLON RIDGE MARKETPLACE

REPLAT B

REC.# 570108

Δ=12°16'30"

L=110.98'(R)

(36 PUBLIC ROW)

_ NO EASEMENT

N09°29'51"W

FOUND 1"

YELLOW PLASTIC CAP - ILLEGIBLE

33.15'(R)

N77°22'57"W N77°40'50"W

36.35'(R) 36.12'(M)

S64°57'16"W S64°42'52"W

19.91'(R) 19.91'(M)

R=518.00'=

Δ=79°46'57"

L=20.89'(R)

Δ=1°41'35"

R=282.00'

DILLON RIDGE MARKETPLACE

REC.# 615489

3\\15' UTILITY EASEMENT

(TC1 #9) (TC2 #9)

REC.# 535200 ^{*}

TC1 #9 TC2 #9

20' UTILITY EASEMENT

L=8.33'(R)

R=15.00'-

Δ=79*25'54"

L=55.45'(R)

POINT OF

BEGINNING
PARCEL B, TC #1

S89°20'12"E 206.07'(R)

S89°20'33"E 206.14'(M)

N14°50'19"W N14°43'50"W

PARCEL B REC.# 655933

27.91'(R) 27.69'(M)

12.5' UTILITY EASEMENT -

REC.# 533030 & REC.# 655933

N00'37'05"E N00'37'20"E

18.25'(R) 18.25'(M)

TC, NO., 1

-20' WATER & SEWER EASEMENT

TC1 #1D TC2 #1D

SE1/4 SEC. 7,

T.5S., R.77W., SIXTH P.M.

-R=40.00'

LOOKOUT RIDGE HOMEOWNERS ASSOC.

Δ=9*38'18"

L=27.25'(R)

R=162.00'-

Δ=9°36'44"

R=162.00'

L=27.18'(M)

FUTURE PHASE TRACT B LOOKOUT RIDGE TOWNHOMES

PHASE 1

Δ=40°31'05"

L=61.52'(R)

Δ=40°33'45"

R=87.00'

L=61.59'(M)

24' ACCESS EASEMENT

REC.# 533030, REC.# 541965, REC.# 655933 & REC.# 655934

TC1 #23 TC1 #25 TC1 #26)

MONUMENT SYMBOL LEGEND

CAP STAMPED "LS 28258"

▲ STAMPED "PLS 15242"

FOUND 1" YELLOW PLASTIC

FOUND 2" ALUMINUM CAP

FOUND 2" ALUMINUM CAP

STAMPED "PLS 15242 5' WC"

FOUND 1" YELLOW PLASTIC

CAP STAMPED "PLS 37990"

FOUND SURVEY MONUMENT AS DESCRIBED

FOUND 2" ALUMINUM CAP STAMPED "LS 26292"

STAMPED "LS 26292"

FOUND 1.5" ALUMINUM WASHER

FOUND 2" ALUMINUM CAP STAMPED "5.0' WC LS 26292"

(R) RECORDED BEARING AND DISTANCE

WC WITNESS CORNER

SET #5 REBAR W/ 1-1/4" YELLOW

MEASURED BEARING AND DISTANCE

PLASTIC CAP STAMPED "AZTEC LS 37933"

R=87.00'-

FIRST AMENDMENT

LOOKOUT RIDGE TOWNHOMES

REC.# 655933

HOMEOWNERS ASSOC.

REC.# 877492

NO EASEMENT

SKYLINE CINEMA 8 LLC

BLOCK 5 DILLON RIDGE MARKETPLACE

REPLAT B REC.# 570108

FIRE HYDRANT EASEMENT (C1 #9) (C2 #9)

S89°51'33"E 258.91'(M)

PARCEL CONTAINS

257,406 (SQ.FT.)

5.909 ACRES

MORE OR LESS

TC NO. 2

S89°51'54"E 258.90'(R)

TC NO. 1

DILLON RIDGE MARKETPLACE

REPLAT C

REC.# 615489

N64°33'40"W

DILLON RIDGE MARKETPLACE

REPLAT 🕻

REC.# 615489

20' WATER & SEWER EASEMENT

REC.# 188543 TC1 #11) TC2 #11

TC1 #9) TC2 #9) 15' UTILITY EASEMENT REC.# 535200 45.84'(R)

NO BUILDING OBSERVED

ON SUBJECT PARCELS

DILLON RIDGE ROAD

TC1/#16 TQ2 #14) 10' IRRIGATION LINE EASEMENT

(APPROXIMATE LOCATION)

N87°37'56"W _ 35.89'(R)

TC1 #9 TC2 #9

5' UTILITY & SNOW

STORAGE EASEMENT

REC.# 535200

REC.# 621275

8° (6°) (18°) (10°) Δ=89°27′25″

R=25.00'

R = 25.00'


L=39.03'(R)

Δ=89°29'51"

NOR'

DILLON



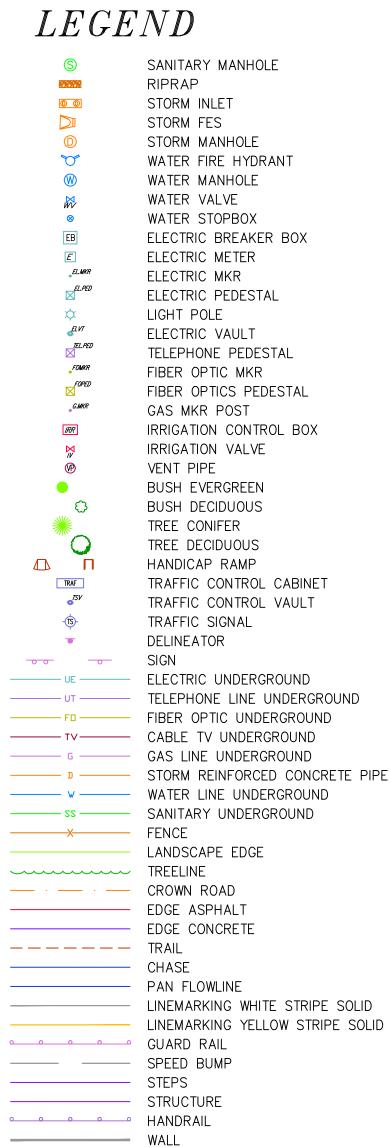

SURVEY 6TH P.M. ORADO

LAND T5S,

ra/nsp: sec.

2 SHEETS

137018-01

ASPHALT PAVEMENT GRAVEL

FOR AND ON BEHALF OF AZTEC CONSULTANTS, INC

DILLON RIDGE MARKETPLACE REPLAT E

A REPLAT OF BLOCKS 12, 13 AND 14, DILLON RIDGE MARKETPLACE REPLAT C AND A PORTION OF FUTURE PHASE TRACT B, LOOKOUT RIDGE TOWNHOMES PHASE 1, SITUATED IN THE SOUTH HALF OF SECTION 7,

TOWNSHIP 5 SOUTH, RANGE 77 WEST OF THE SIXTH PRINCIPAL MERIDIAN, TOWN OF DILLON, COUNTY OF SUMMIT, STATE OF COLORADO.

OWNER'S CERTIFICATE

KNOW ALL MEN BY THESE PRESENTS: THAT TEN MILE HOLDINGS, LLC, BEING THE OWNERS OF THE FOLLOWING DESCRIBED

BLOCKS 12, 13 AND 14, DILLON RIDGE MARKETPLACE REPLAT C, ACCORDING TO THE PLAT RECORDED JANUARY 19, 2000 UNDER RECEPTION NO. 615489, COUNTY OF SUMMIT, STATE OF COLORADO.

AND A PORTION OF "FUTURE PHASE TRACT B", ACCORDING TO THE PLAT FILED FOR FIRST AMENDMENT TO: LOOKOUT RIDGE TOWNHOMES PHASE I, RECORDED JUNE 27, 2001 UNDER RECEPTION NO. 655933, COUNTY OF SUMMIT, STATE OF COLORADO: AND MORE PARTICULARLY DESCRIBED AS FOLLOWS:

COMMENCING AT THE NORTHWESTERLY CORNER OF PHASE IV, LOOKOUT RIDGE TOWNHOMES, ACCORDING TO THE FIRST AMENDMENT TO LOOKOUT RIDGE TOWNHOMES PHASE IV RECORDED JUNE 27, 2001 UNDER RECEPTION NO. 655933 IN SAID CLERK AND RECORDER OFFICE, THENCE SOUTH 00 DEGREES 37 MINUTES 05 SECONDS WEST ALONG THE WESTERLY LINE OF SAID PHASE IV, ALSO BEING THE EASTERLY LINE OF DILLON RIDGE MARKETPLACE 392.63 FEET TO THE SOUTHWEST CORNER OF SAID PHASE IV AND THE TRUE POINT OF

THENCE EASTERLY ALONG THE SOUTHERLY BOUNDARY OF SAID PHASE IV, FOR THE

FOLLOWING 3 COURSES: SOUTH 89 DEGREES 20 MINUTES 12 SECONDS EAST A DISTANCE OF 206.07 FEET 27.25 FEET ALONG THE ARC OF A NON-TANGENT CURVE TO THE LEFT HAVING A CENTRAL ANGLE OF 09 DEGREES 38 MINUTES 18 SECONDS A RADIUS OF 162.00 FEET AND A CHORD WHICH BEARS NORTH 88 DEGREES 27 MINUTES 53 SECONDS EAST 27.22 FEET DISTANT; 61.52 FEET ALONG THE ARC OF A NON-TANGENT CURVE TO THE LEFT HAVING A CENTRAL ANGLE OF 40 DEGREES 31 MINUTES 05 SECONDS A RADIUS OF 87.00 FEET AND A CHORD WHICH BEARS NORTH 61 DEGREES 15 MINUTES 28 SECONDS EAST FEET DISTANT TO A POINT OF THE SOUTHERLY BOUNDARY OF PHASE III, LOOKOUT RIDGE TOWNHOMES, A SUBDIVISION RECORDED MAY 1, 1998 UNDER RECEPTION NO. 564721; THENCE SOUTH 60 DEGREES 44 MINUTES 17 SECONDS EAST ALONG SAID BOUNDARY A DISTANCE OF 96.87 FEET TO THE SOUTHEASTERLY BOUNDARY OF SAID PHASE I, ALSO BEING THE NORTH RIGHT OF WAY LINE OF U.S. HIGHWAY NO. 6; THENCE SOUTHWESTERLY ALONG SAID RIGHT OF WAY LINE FOR THE FOLLOWING TWO SOUTH 53 DEGREES 41 MINUTES 26 SECONDS WEST A DISTANCE OF 180.80 FEET: SOUTH 56 DEGREES 46 MINUTES 59 SECONDS WEST A DISTANCE OF 199.92 FEET TO THE

WESTERLY BOUNDARY OF SAID PHASE I, BEING THE EASTERLY BOUNDARY OF BLOCK 13, DILLON RIDGE MARKETPLACE, REPLAT C, A SUBDIVISION RECORDED JANUARY 19, 2000 UNDER RECEPTION NO. 615489; THENCE NORTHERLY ALONG SAID BOUNDARY FOR THE FOLLOWING TWO COURSES; NORTH 14 DEGREES 50 MINUTES 19 SECONDS WEST A DISTANCE OF 225.90 FEET; NORTH 00 DEGREES 37 MINUTES 05 SECONDS EAST A DISTANCE OF 18.25 FEET TO THE POINT OF BEGINNING.

CONTAINING AN AREA OF 5.909 ACRES, (257,406 SQUARE FEET), MORE OR LESS.

HAVE LAID OUT AND PLATTED THE SAME INTO A LOT AND EASEMENTS SHOWN HEREON UNDER THE NAME AND AND STYLE OF "DILLON RIDGE MARKETPLACE REPLAT E" AND BY THESE PRESENTS, DO HEREBY SET APART AND DEDICATE TO THE PERPETUAL USE OF THE PUBLIC ALL OF THE STREETS AND OTHER PUBLIC WAYS AND PLACES AS SHOWN HEREON AND DO HEREBY DEDICATE THOSE PORTIONS OF LAND LABELED AS EASEMENTS FOR THE INSTALLATION AND MAINTENANCE OF PUBLIC UTILITIES, TOWN WATER, TOWN SANITARY SEWER, TOWN RIGHT-OF-WAY, TOWN SIDEWALK AND ACCESS, TOWN SNOW STORAGE, AND DRAINAGE AND DETENTION AS SHOWN HEREON. (AND/OR OTHER PURPOSES)

IN WITNESS WHEREOF, ______, AS ______OF TEN MILE HOLDINGS, LLC, HAVE CAUSED THEIR NAMES TO BE HEREUNTO SUBSCRIBED THIS _____ DAY OF _____, A.D., 2018.

TEN MILE HOLDINGS, LLC,

BY


AS
STATE OF COLORADO)


THE FOREGOING INSTRUMENT OF "DILLON RIDGE MARKETPLACE REPLAT E," WAS ACKNOWLEDGED BEFORE ME THIS _____ DAY OF ____, A.D., 2018, BY, AS _____ OF TEN MILE HOLDINGS, LLC.

WITNESS MY HAND AND OFFICIAL SEAL.
MY COMMISSION EXPIRES: ________

NOTARY PUBLIC

COUNTY OF SUMMIT

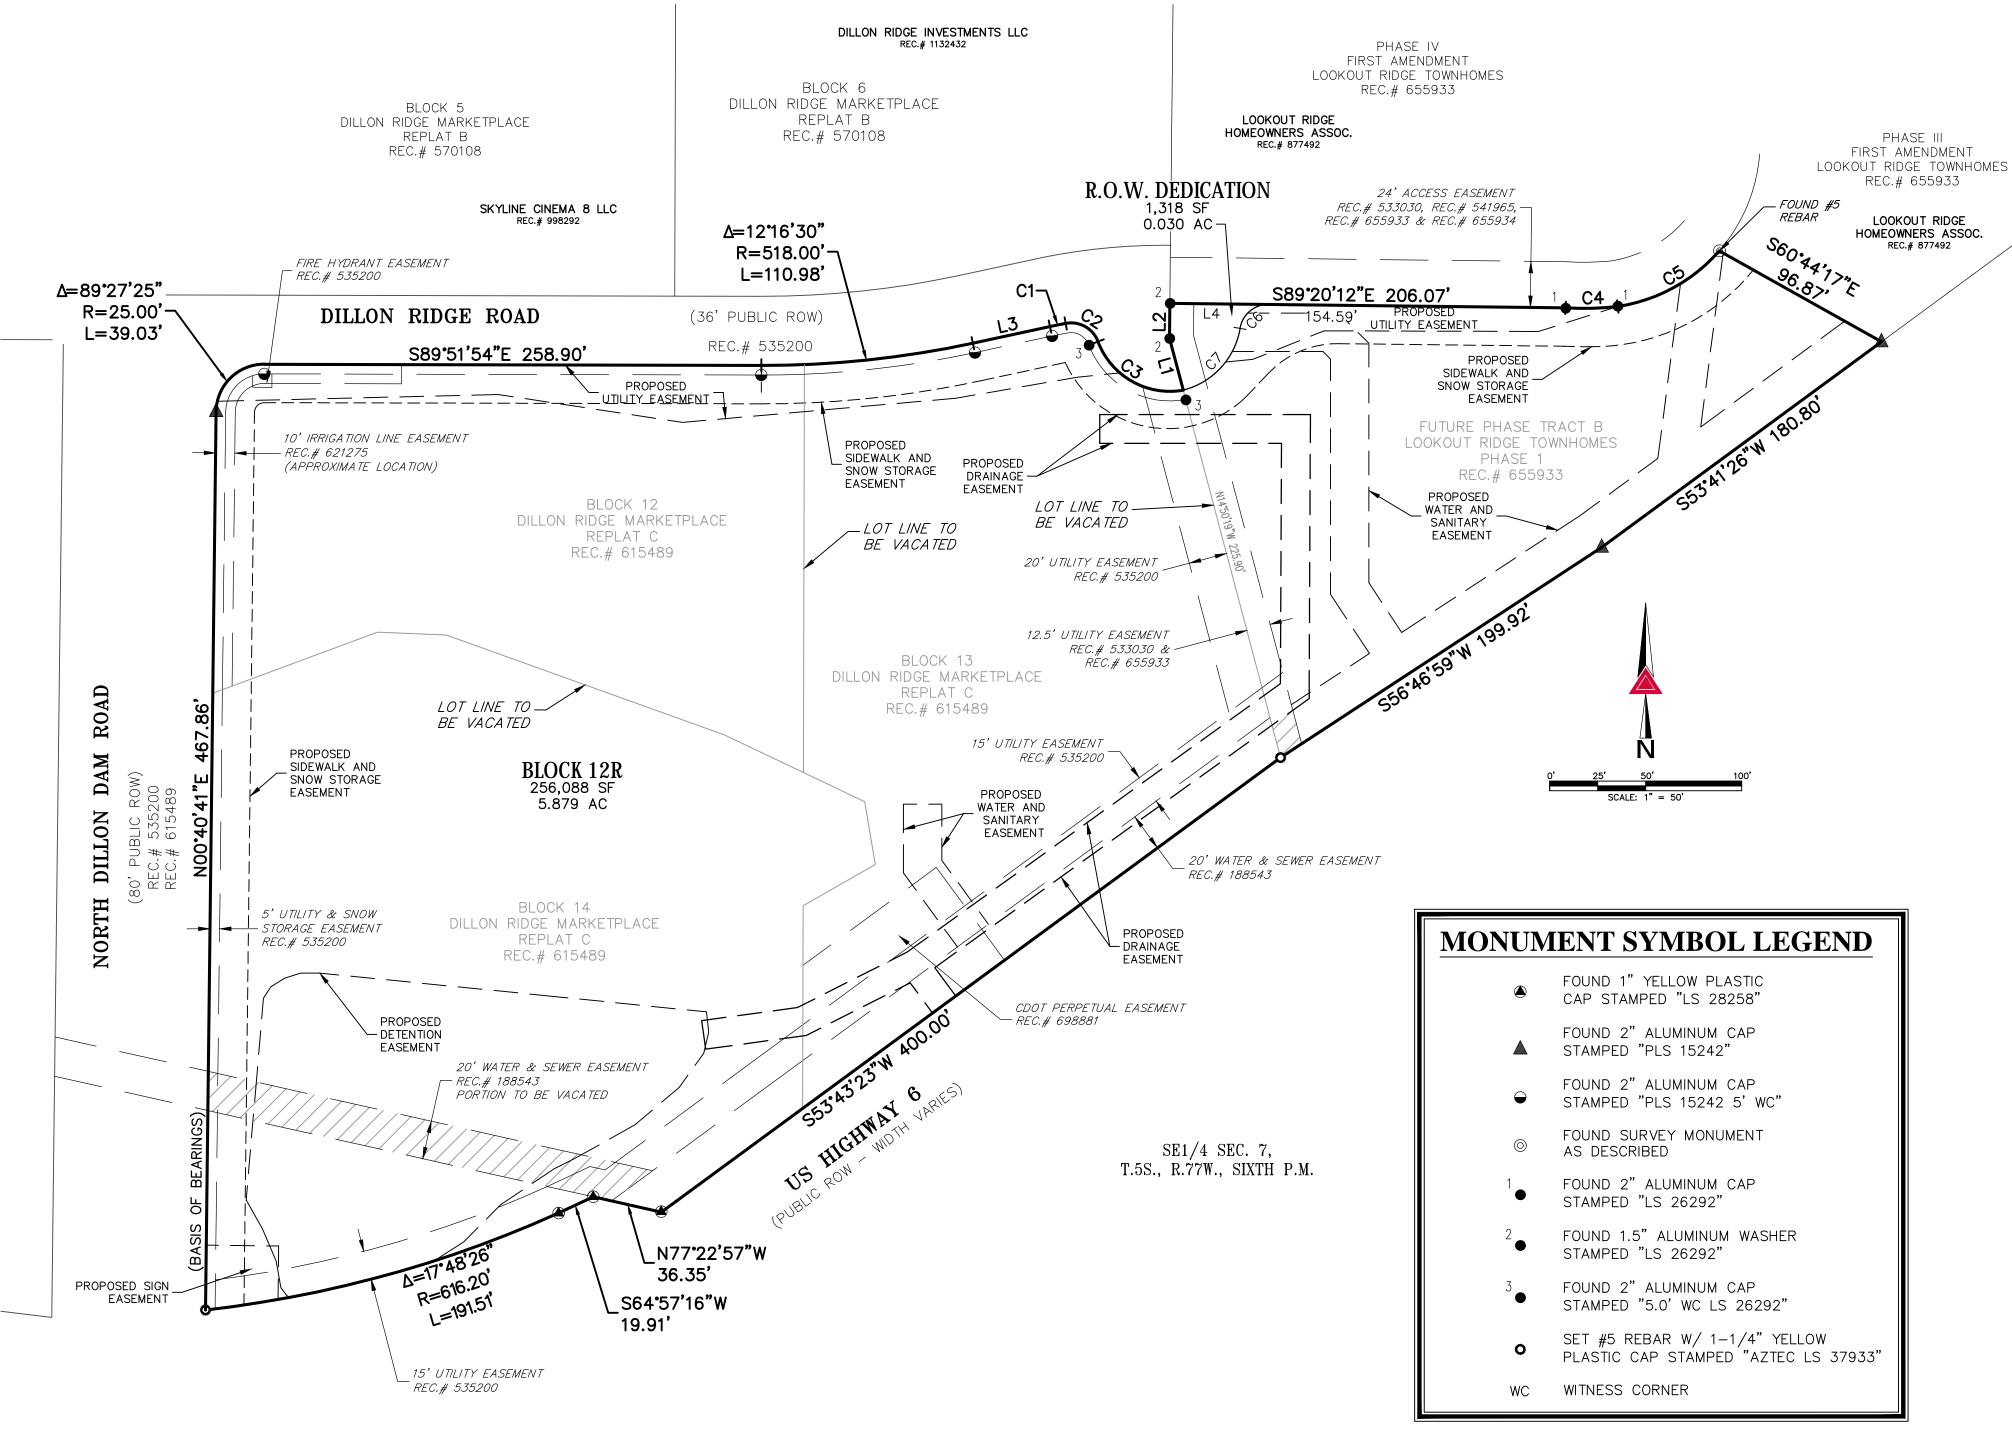

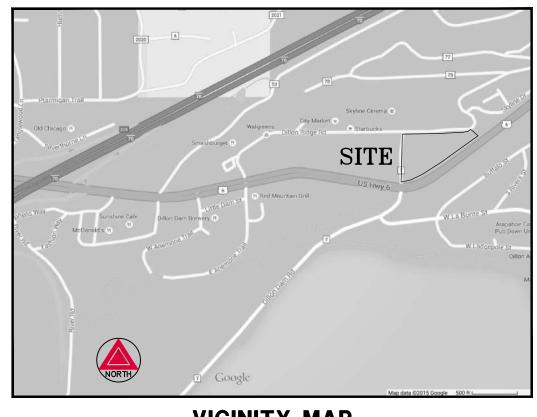

VICINITY MAP

N. T. S.

CERTIFICATE OF TAXES PAID

I, THE UNDERSIGNED, DO HEREBY CERTIFY THAT THE ENTIRE AMOUNT OF ALL TAXES DUE AND PAYABLE AS OF ______, 20__, UPON PARCELS OF REAL ESTATE DESCRIBED ON THIS PLAT ARE PAID IN FULL.

DATED THIS_____ DAY OF_____, 20_, A.D.

SUMMIT COUNTY TREASURER OR DESIGNEE

PLAT NOTES

- 1. PER C.R.S. 38-51-106, "ALL LINEAL UNITS DEPICTED ON THIS LAND SURVEY PLAT ARE U.S. SURVEY FEET. ONE METER EQUALS 39.37/12 U.S. SURVEY FEET, EXACTLY ACCORDING TO THE NATIONAL INSTITUTE OF STANDARDS AND TECHNOLOGY."
- 2. ANY PERSON WHO KNOWINGLY REMOVES, ALTERS OR DEFACES ANY PUBLIC LAND SURVEY MONUMENT OR ACCESSORY COMMITS A CLASS TWO (2) MISDEMEANOR PURSUANT TO STATE STATUTE 18-4-508, C.R.S.

DILLON TOWN COUNCIL CERTIFICATE

APPROVED THIS ______ DAY OF ______, A.D., _____, TOWN COUNCIL, DILLON, COLORADO. THIS APPROVAL DOES NOT GUARANTEE THAT THE SIZE OR SOIL OR FLOODING CONDITIONS OF ANY LOT SHOWN HEREON ARE SUCH THAT A BUILDING PERMIT MAY BE ISSUED. THIS APPROVAL IS WITH THE UNDERSTANDING THAT ALL EXPENSES INVOLVING NECESSARY IMPROVEMENTS FOR ALL UTILITY SERVICES, PAVING, GRADING, LANDSCAPING, CURBS, GUTTERS, STREETLIGHTS, STREET SIGNS, AND SIDEWALKS SHALL BE FINANCED BY OTHERS AND NOT THE TOWN OF DILLON.

CAROLYN SKOWYRA, MAYOR

ATTEST_____
ADRIENNE STUCKEY, TOWN CLERK

NOTICE

(CORPORATE SEAL)

PUBLIC NOTICE IS HEREBY GIVEN THAT ACCEPTANCE OF THIS PLATTED SUBDIVISION BY THE TOWN OF DILLON DOES NOT CONSTITUTE AN ACCEPTANCE OF THE ROADS AND RIGHTS-OF-WAY REFLECTED HEREON FOR MAINTENANCE BY SAID TOWN.

UNTIL SUCH ROADS AND RIGHTS-OF-WAY MEET TOWN ROAD SPECIFICATIONS AND ARE SPECIFICALLY ACCEPTED BY THE TOWN, THE MAINTENANCE, CONSTRUCTION AND ALL OTHER MATTERS PERTAINING TO OR AFFECTING SAID ROADS AND RIGHTS-OF-WAY ARE THE SOLE RESPONSIBILITY OF THE OWNERS OF THE LAND EMBRACED WITHIN THIS SUBDIVISION.

DILLON PLANNING & ZONING COMMISSION CERTIFICATE

APPROVED THIS _____ DAY OF _____, A.D., _____, TOWN PLANNING AND ZONING COMMISSION, DILLON, COLORADO.

SURVEYOR'S CERTIFICATE

KNOWLEDGE, INFORMATION AND BELIEF.

TERESA ENGLAND, CHAIRPERSON

I, JAMES E. LYNCH, BEING A REGISTERED LAND SURVEYOR IN THE STATE OF COLORADO, DO HEREBY CERTIFY THAT THIS PLAT WAS PREPARED BY ME AND UNDER MY SUPERVISION FROM A SURVEY MADE BY ME AND UNDER MY SUPERVISION, THAT BOTH THIS PLAT AND THE SURVEY ARE TRUE AND ACCURATE TO THE BEST OF MY KNOWLEDGE AND BELIEF AND THAT THE MONUMENTS WERE PLACED PURSUANT TO CRS 38-51-101.

DATED THIS______ DAY OF______, 20___, A.D.

NOTICE: ACCORDING TO COLORADO LAW, YOU MUST COMMENCE ANY LEGAL ACTION BASED UPON ANY DEFECT IN THIS SURVEY WITHIN THREE YEARS AFTER YOU FIRST DISCOVER SUCH DEFECT IN NO EVENT, MAY ANY ACTION BASED UPON ANY DEFECT IN THIS SURVEY BE COMMENCED MORE THAN TEN YEARS FROM THE DATE OF THE CERTIFICATION SHOWN HEREON.

NOTICE: PER THE STATE OF COLORADO BOARD OF LICENSURE FOR ARCHITECTS, PROFESSIONAL ENGINEERS, AND PROFESSIONAL LAND SURVEYORS RULE 6.2.2 THE WORD "CERTIFY" AS USED HEREON MEANS AN EXPRESSION OF PROFESSIONAL OPINION AND DOES NOT CONSTITUTE A WARRANTY OR GUARANTEE, EXPRESSED OR IMPLIED. THE SURVEY REPRESENTED HEREON HAS BEEN PERFORMED BY ME OR UNDER MY DIRECT SUPERVISION IN ACCORDANCE WITH APPLICABLE STANDARDS OF PRACTICE AND IS BASED UPON MY

AZTEC 300 East Mineral Ave., Suite 1
Littleton, Colorado 80122
Phone: (303) 713-1898
Fax: (303) 713-1897
www.aztecconsultants.com

AzTec Proj. No.: 141218-01

Drawn By: JEL

DEVELOPER

DATE OF PREPARATION: 7/8/2019

TEN MILE HOLDINGS, LLC

101 SOUTH MAIN STREET
BRECKENRIDGE, COLORADO
970-453-0550

SHEET 1 OF 1

	LINE TABLE	
LINE	BEARING	LENGTH
L1	N14°50'19"W	27.91'
L2	N00°37'05"E	18.25'
L3	N77°51'32"E	41.11'
L4	S89°20'12"E	51.48'

CURVE TABLE				
CURVE	DELTA	RADIUS	LENGTH	CHORD
C1	1°41'35"	282.00'	8.33'	S78°42'20"W, 8.33'
C2	79°46'57"	15.00'	20.89'	N60°33'25"W, 19.24
C3	79°25'54"	40.00'	55.45	S60°22'53"E, 51.12'
C4	9°38'18"	162.00'	27.25'	N88°27'53"E, 27.22'
C5	40°31'05"	87.00'	61.52'	N61°15'28"E, 60.25'
C6	81°06'34"	15.00'	21.23'	S50°06'31"W, 19.51'
C7	66°08'14"	40.00'	46.17'	N42°37'21"E, 43.65'

TOWN CLERK'S CERTIFICATE

STATE OF COLORADO)

) SS.

TOWN OF DILLON)

I HEREBY CERTIFY THAT THIS INSTRUMENT WAS FILED IN MY OFFICE AT _____O'CLOCK,
_____A.D., _____, AND IS DULY RECORDED.

TITLE COMPANY'S CERTIFICATE


ADRIENNE STUCKEY, TOWN CLERK

DOES HEREBY CERTIFY
THAT WE HAVE EXAMINED THE TITLE TO ALL LANDS SHOWN HEREON AND ALL LANDS HEREIN
DEDICATED BY THE VIRTUE OF THIS PLAT AND TITLE TO ALL SUCH LANDS IS IN THE
DEDICATOR FREE AND CLEAR OF ALL LIENS, TAXES AND ENCUMBRANCES, EXCEPT AS FOLLOWS:

DATED THIS_____ DAY. OF_____, A.D.____

CLERK AND RECORDER'S CERTIFICATE

SUMMIT COUNTY CLERK AND RECORDER

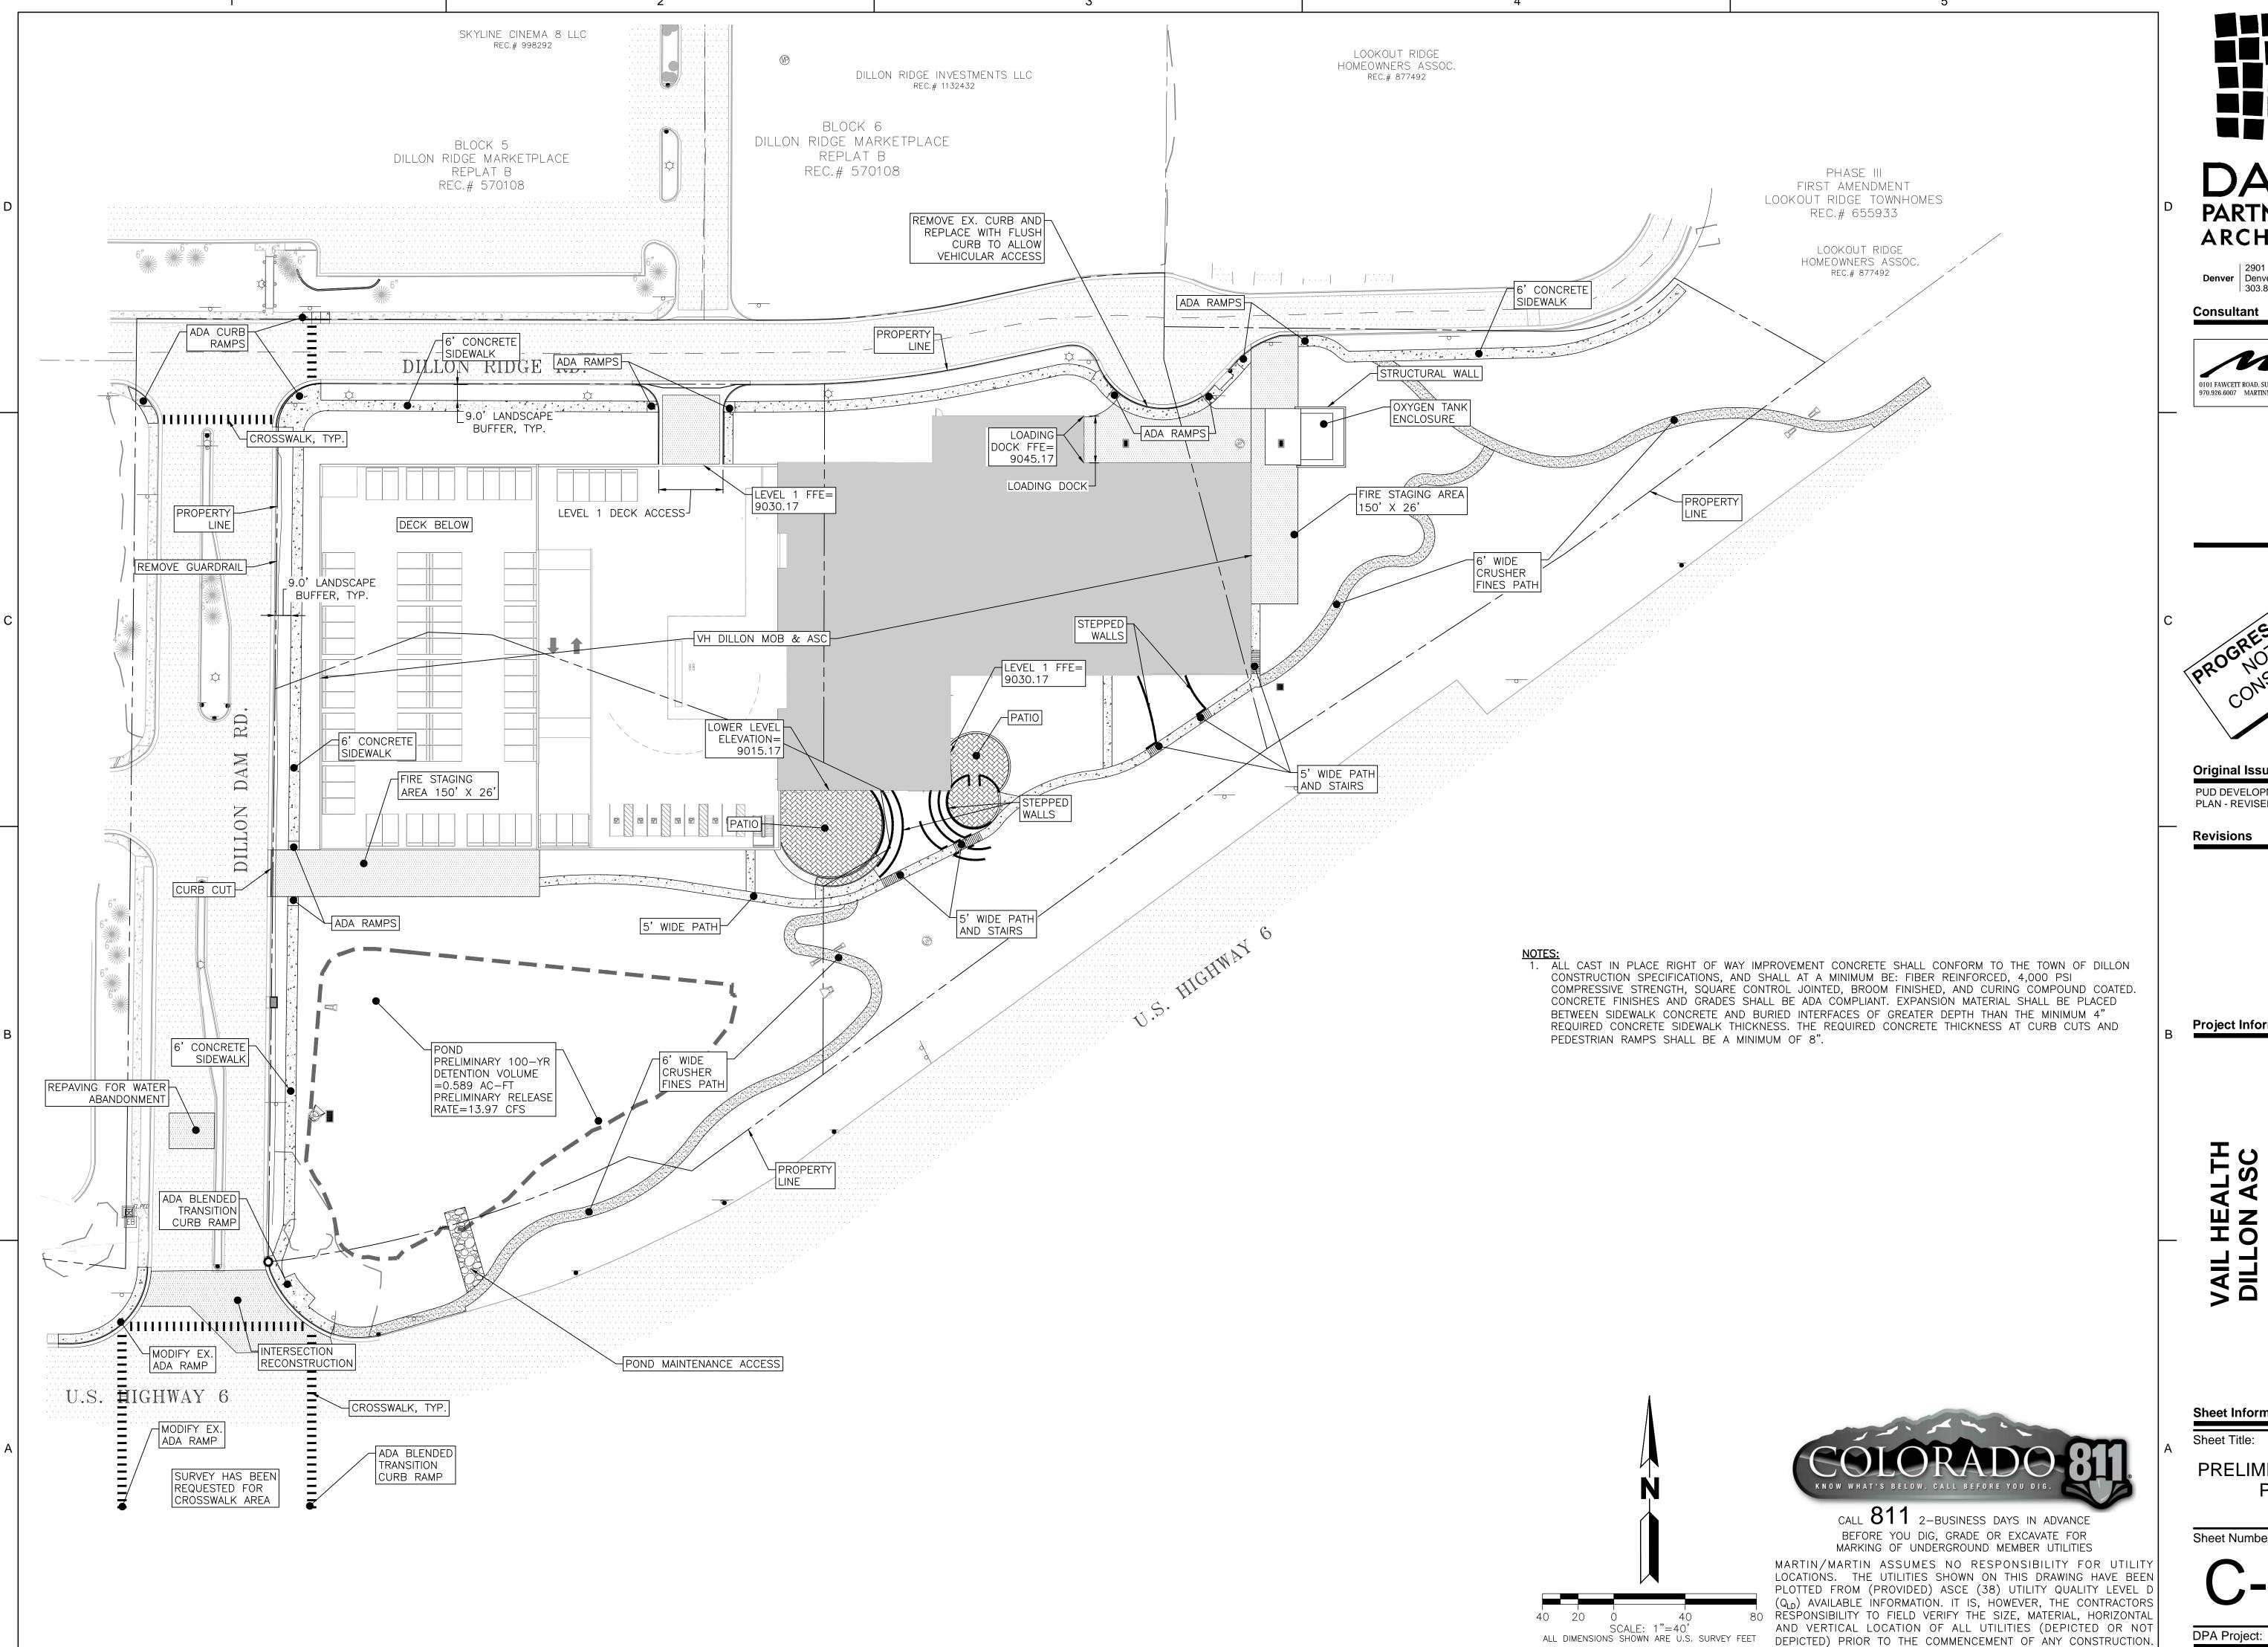

DAVIS PARTNERSHIP ARCHITECTS

Denver | 2901 Blake Street, Suite 100 Denver, CO 80205 303.861.8555

Consultant





Original Issuance PUD DEVELOPMENT

PLAN - REVISED

07/23/2019

Date No.

Project Information

VAIL DILL


Sheet Information


Sheet Title:

PRELIMINARY SITE PLAN

Sheet Number:


18917.00

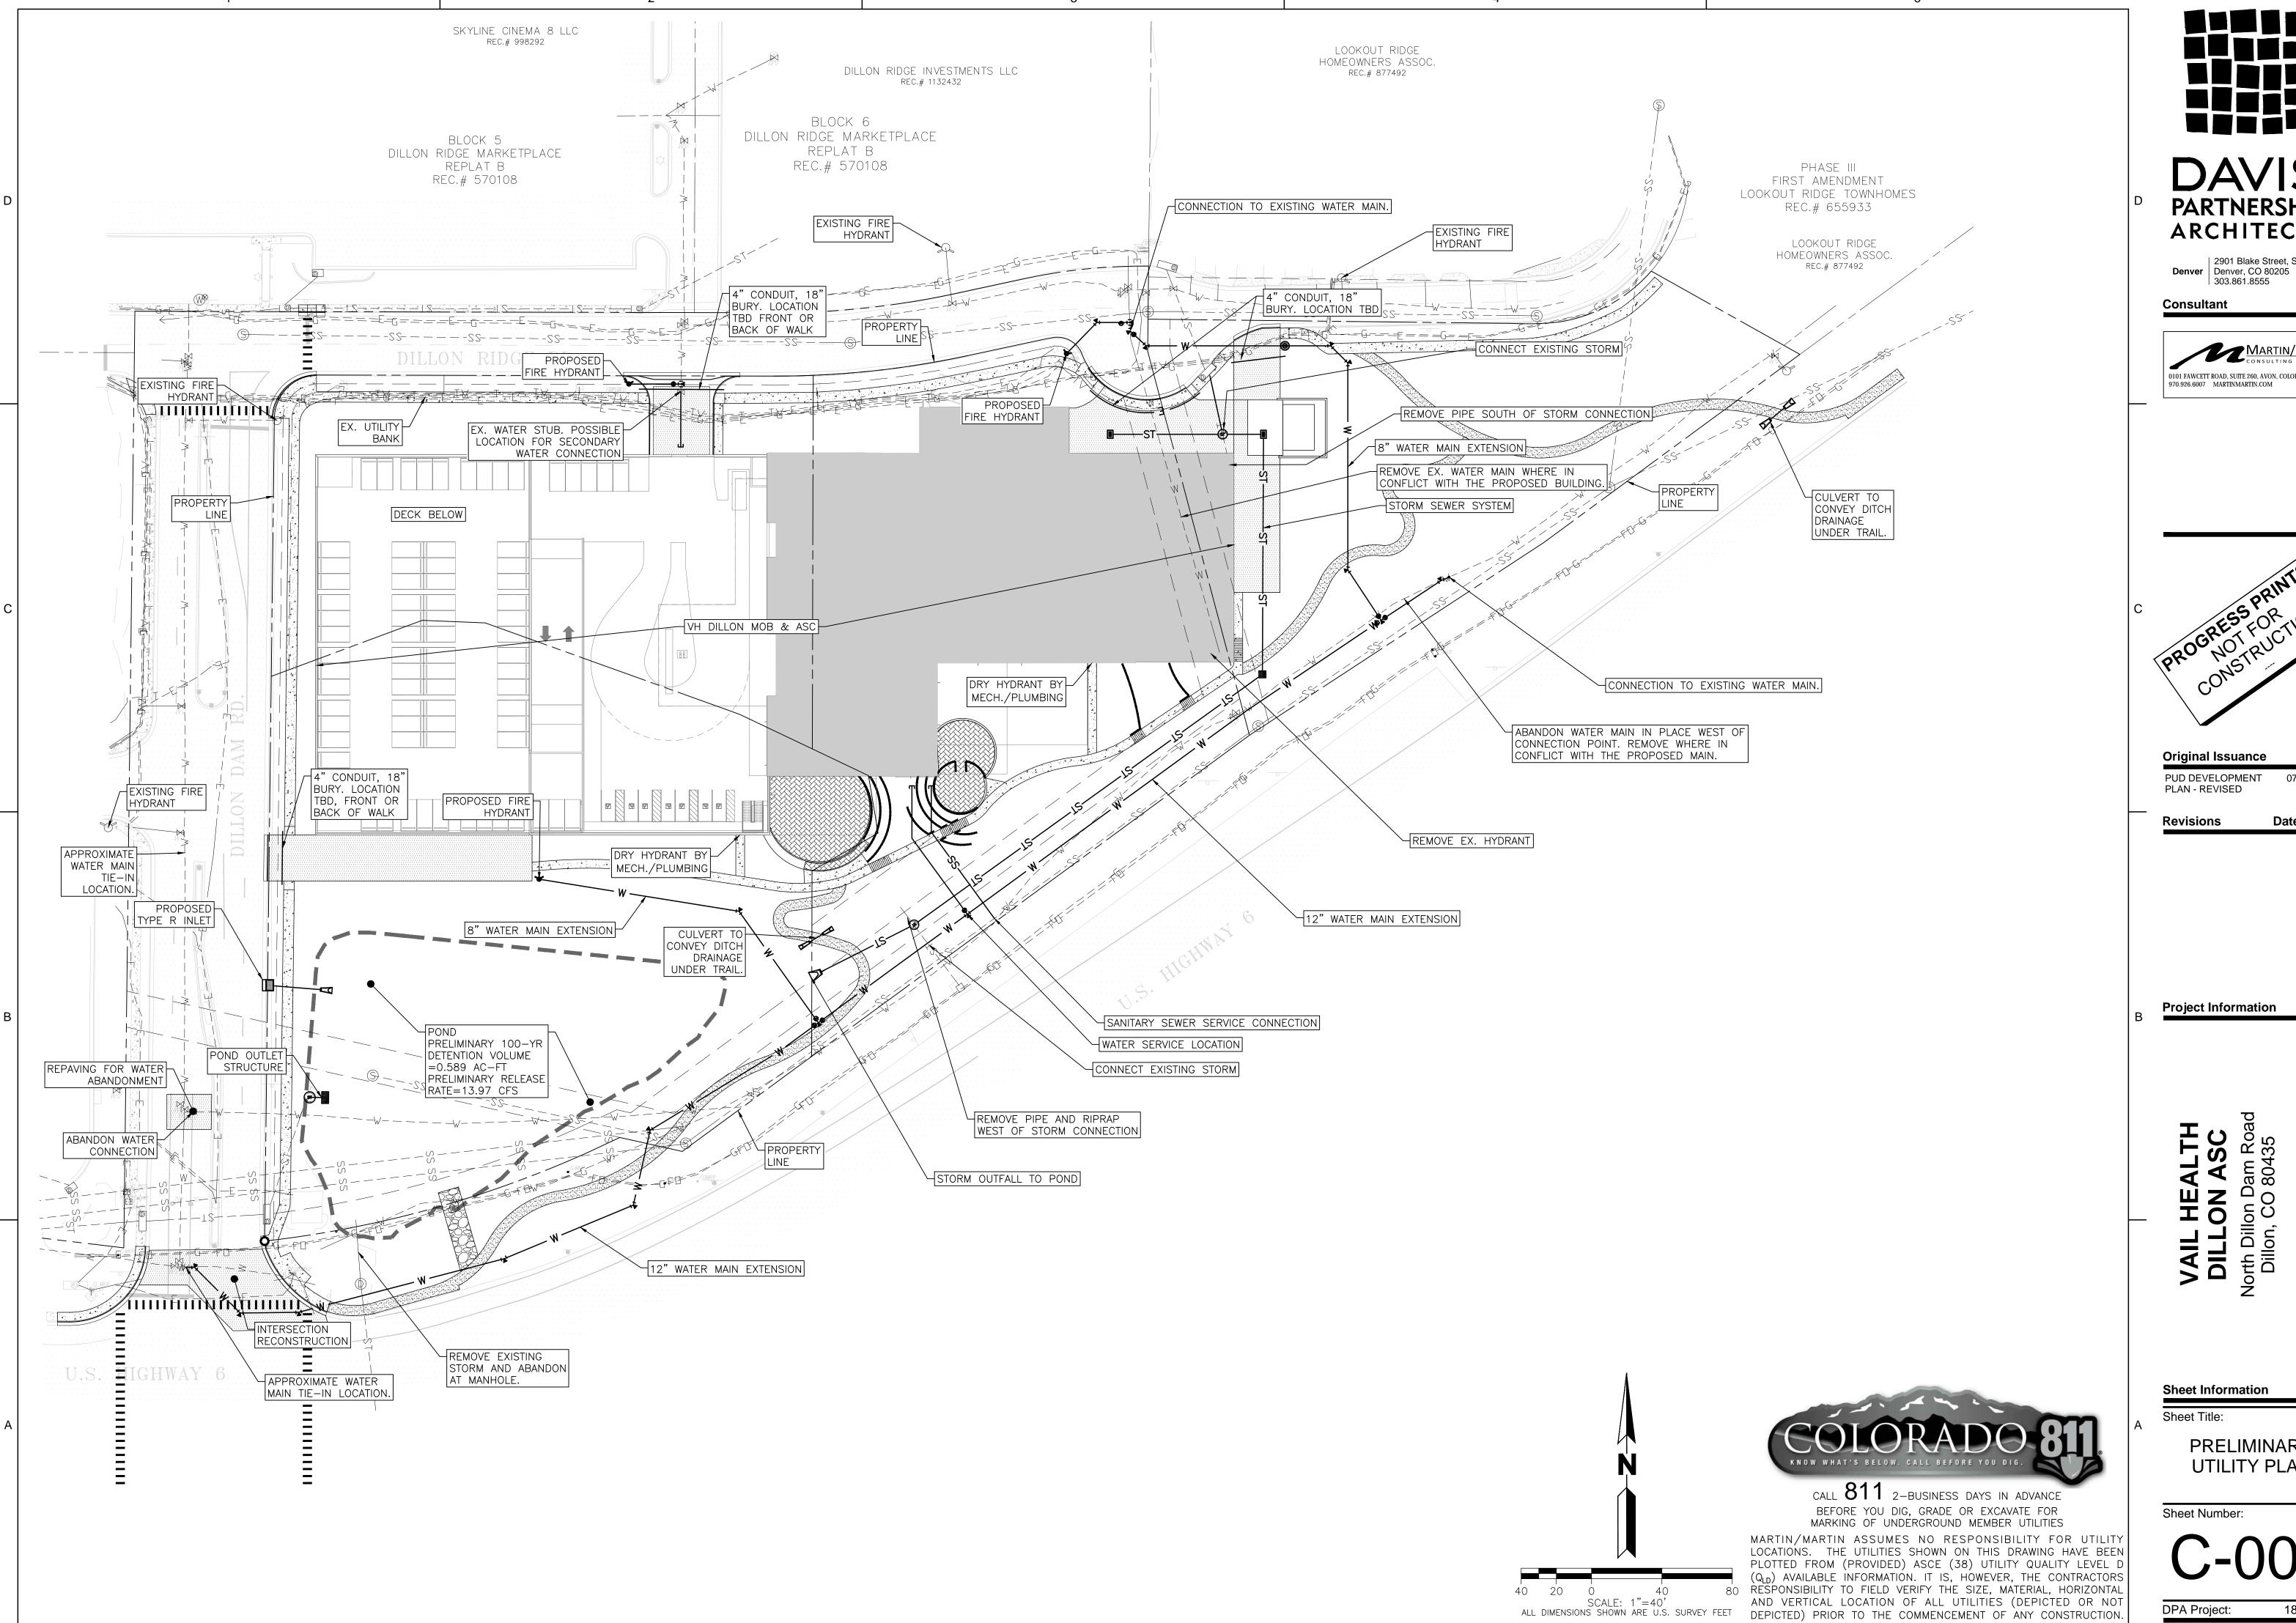

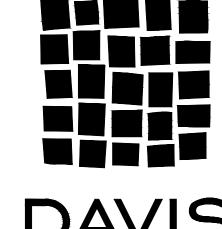

DAVIS PARTNERSHIP ARCHITECTS

Consultant

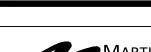





Original Issuance 07/23/2019

PUD DEVELOPMENT PLAN - REVISED

Revisions

Date No.

HO ON VAIL

Sheet Information


Sheet Title:

PRELIMINARY UTILITY PLAN

Sheet Number:

DPA Project:

18917.00

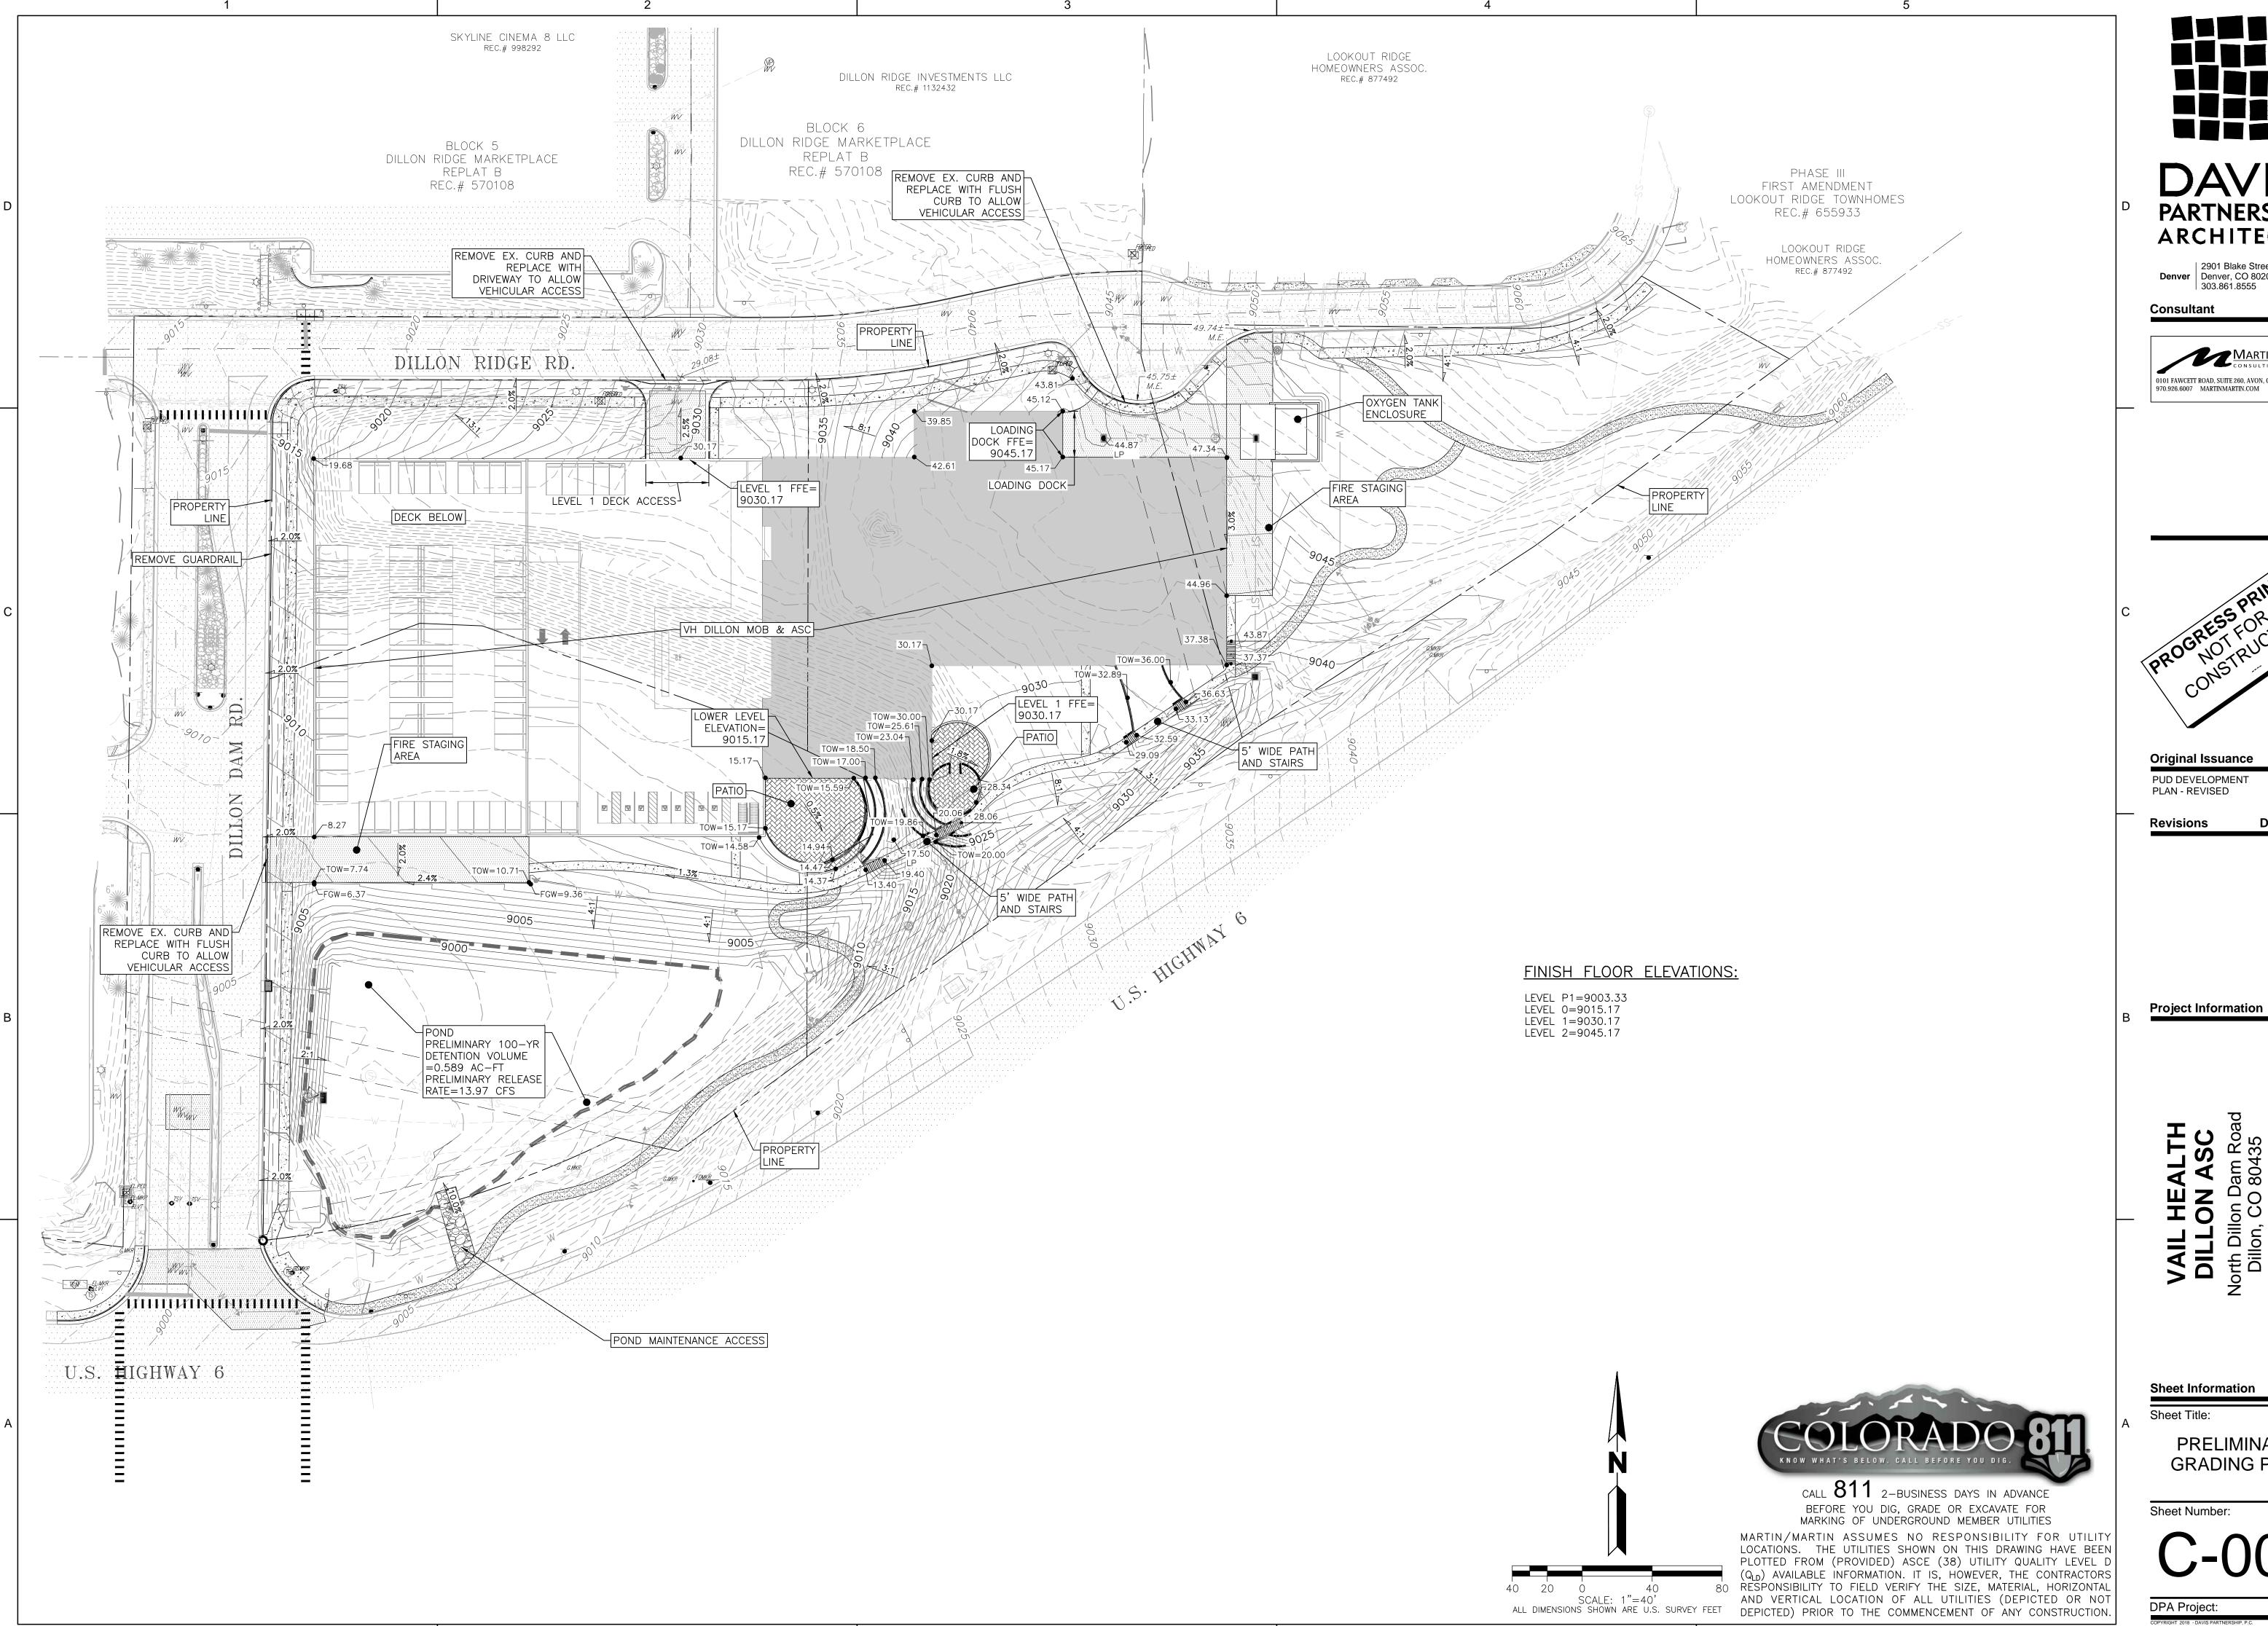

DAVIS PARTNERSHIP ARCHITECTS

Denver | 2901 Blake Street, Suite 100 Denver, CO 80205 303.861.8555

Consultant





Original Issuance PUD DEVELOPMENT 07/23/2019

PLAN - REVISED

Date No.

Revisions

VAIL DILL

Sheet Information

Sheet Title:

PRELIMINARY **GRADING PLAN**

Sheet Number:

DPA Project:

18917.00

GENERAL NOTES

- THESE PLANS SHALL NOT BE UTILIZED FOR CONSTRUCTION OR PERMITTING UNLESS STATED FOR SUCH USE IN THE TITLE BLOCK. DRAWINGS ARE INTENDED TO BE PRINTED ON 24" X 36" PAPER. PRINTING THESE DRAWINGS
- REFERENCING ANY MEASUREMENTS ON THESE SHEETS. THE RECIPIENT OF THESE DRAWINGS SHALL BE RESPONSIBLE FOR ANY ERRORS RESULTING FROM INCORRECT PRINTING, COPYING, OR ANY OTHER CHANGES THAT ALTER THE SCALE OF THE DRAWINGS. VERIFY ALL PLAN DIMENSIONS PRIOR TO START OF CONSTRUCTION. NOTIFY THE OWNER'S

AT A DIFFERENT SIZE WILL IMPACT THE SCALE. VERIFY THE GRAPHIC SCALE BEFORE

- REPRESENTATIVE TO ADDRESS ANY QUESTIONS OR CLARIFY ANY DISCREPANCIES.
- WRITTEN DIMENSIONS TAKE PRECEDENCE OVER SCALED DIMENSIONS SUBMIT A CHANGE ORDER FOR APPROVAL FOR ANY CHANGES TO WORK SCOPE RESULTING FROM FIELD CONDITIONS OR DIRECTION BY OWNER'S REPRESENTATIVE WHICH REQUIRE
- ADDITIONAL COST TO THE OWNER PRIOR TO PERFORMANCE OF WORK THE CONTRACTOR SHALL PROVIDE A STAKED LAYOUT OF ALL SITE IMPROVEMENTS FOR INSPECTION BY THE OWNER'S REPRESENTATIVE AND MAKE MODIFICATIONS AS REQUIRED. ALL LAYOUT INFORMATION IS AVAILABLE IN DIGITAL FORMAT FOR USE BY THE CONTRACTOR. IF A GEOTECHNICAL SOILS REPORT IS NOT AVAILABLE AT THE TIME OF CONSTRUCTION, NORRIS DESIGN RECOMMENDS A REPORT BE AUTHORIZED BY THE OWNER AND THAT ALL RECOMMENDATIONS OF THE REPORT ARE FOLLOWED DURING CONSTRUCTION THE CONTRACTOR SHALL USE THESE CONTRACT DOCUMENTS AS A BASIS FOR THE BID. IF THE OWNER ELECTS TO PROVIDE A GEOTECHNICAL REPORT, THE CONTRACTOR SHALL REVIEW THE REPORT AND SUBMIT AN APPROPRIATE CHANGE ORDER TO THE OWNER'S REPRESENTATIVE IF ADDITIONAL COSTS ARE REQUESTED
- CONTRACTOR SHALL CONFIRM THAT SITE CONDITIONS ARE SIMILAR TO THE PLANS, WITHIN TOLERANCES STATED IN THE CONTRACT DOCUMENTS, AND SATISFACTORY TO THE CONTRACTOR PRIOR TO START OF WORK. SHOULD SITE CONDITIONS BE DIFFERENT THAN REPRESENTED ON THE PLANS OR UNSATISFACTORY TO THE CONTRACTOR, THE CONTRACTOR SHALL CONTACT THE OWNER'S REPRESENTATIVE FOR CLARIFICATION AND
- FURTHER DIRECTION. CONTRACTOR IS RESPONSIBLE TO PAY FOR, AND OBTAIN, ANY REQUIRED APPLICATIONS. PERMITTING, LICENSES, INSPECTIONS AND METERS ASSOCIATED WITH WORK
- 10. THE CONTRACTOR SHALL BE RESPONSIBLE FOR ANY FINES OR PENALTIES ASSESSED TO THE OWNER RELATING TO ANY VIOLATIONS OR NON-CONFORMANCE WITH THE PLANS, SPECIFICATIONS, CONTRACT DOCUMENTS, JURISDICTIONAL CODES, AND REGULATORY
- AGENCIES. 1. THE CONTRACTOR SHALL BE RESPONSIBLE FOR COORDINATION OF ALL UTILITY LOCATES PRIOR TO ANY EXCAVATION. REFER TO ENGINEERING UTILITY PLANS FOR ALL PROPOSED UTILITY LOCATIONS AND DETAILS. NOTIFY OWNER'S REPRESENTATIVE IF EXISTING OR PROPOSED UTILITIES INTERFERE WITH THE ABILITY TO PERFORM WORK.
- 2. UNLESS IDENTIFIED ON THE PLANS FOR DEMOLITION OR REMOVAL, THE CONTRACTOR IS RESPONSIBLE FOR THE COST TO REPAIR UTILITIES, ADJACENT OR EXISTING LANDSCAPE, ADJACENT OR EXISTING PAVING, OR ANY PUBLIC AND PRIVATE PROPERTY THAT IS DAMAGED BY THE CONTRACTOR OR THEIR SUBCONTRACTOR'S OPERATIONS DURING INSTALLATION, ESTABLISHMENT OR DURING THE SPECIFIED MAINTENANCE PERIOD. ALL DAMAGES SHALL BE REPAIRED TO PRE-CONSTRUCTION CONDITIONS AS DETERMINED BY THE OWNER'S REPRESENTATIVE. CONTRACTOR SHALL BE RESPONSIBLE FOR LOGGING ANY DAMAGES
- PRIOR TO START OF CONSTRUCTION AND DURING THE CONTRACT PERIOD. 3. ALL WORK SHALL BE CONFINED TO THE AREA WITHIN THE CONSTRUCTION LIMITS AS SHOWN ON THE PLANS. ANY AREAS OR IMPROVEMENTS DISTURBED OUTSIDE THESE LIMITS SHALL BE RETURNED TO THEIR ORIGINAL CONDITION AT THE CONTRACTOR'S EXPENSE. IN THE EVENT THE CONTRACTOR REQUIRES A MODIFICATION TO THE CONSTRUCTION LIMITS, WRITTEN PERMISSION MUST BE OBTAINED FROM THE OWNER'S REPRESENTATIVE PRIOR TO ANY
- DISTURBANCE OUTSIDE OF THE LIMITS OF WORK. 14. THE CONTRACTOR SHALL BE RESPONSIBLE FOR THE REPAIR OF ANY OF THEIR TRENCHES OR
- 15. THE CONTRACTOR SHALL BE RESPONSIBLE TO PREPARE AND SUBMIT A TRAFFIC CONTROL PLAN TO THE APPROPRIATE JURISDICTIONAL AGENCIES AND THE OWNER'S REPRESENTATIVE IF THEIR WORK AND OPERATIONS AFFECT OR IMPACT THE PUBLIC RIGHTS-OF-WAY. OBTAIN APPROVAL PRIOR TO ANY WORK WHICH AFFECTS OR IMPACTS THE PUBLIC RIGHTS-OF-WAY. THE CONTRACTOR SHALL BE RESPONSIBLE FOR ANY FINES OR PENALTIES ASSESSED TO THE
- OWNER RELATING TO THIS REQUIREMENT DURING THE CONTRACT PERIOD. ——16. SIGHT TRIANGLES AND SIGHT LINES SHALL REMAIN UNOBSTRUCTED BY EQUIPMENT, CONSTRUCTION MATERIALS, PLANT MATERIAL OR ANY OTHER VISUAL OBSTACLE DURING THE CONTRACT PERIOD AND AT MATURITY OF PLANTS PER LOCAL JURISDICTIONAL REQUIREMENTS. NO PLANT MATERIAL OTHER THAN GROUND COVER IS ALLOWED TO BE
- PLANTED ADJACENT TO FIRE HYDRANTS AS STIPULATED BY JURISDICTIONAL REQUIREMENTS. 17. COORDINATE SITE ACCESS, STAGING, STORAGE AND CLEANOUT AREAS WITH OWNER'S REPRESENTATIVE. 18. CONTRACTOR IS RESPONSIBLE FOR PROVIDING TEMPORARY SAFETY FENCING AND BARRIERS
- AROUND ALL IMPROVEMENTS SUCH AS WALLS, PLAY STRUCTURES, EXCAVATIONS, ETC. ASSOCIATED WITH THEIR WORK UNTIL SUCH FACILITIES ARE COMPLETELY INSTALLED PER THE PLANS, SPECIFICATIONS AND MANUFACTURER'S RECOMMENDATIONS. 19. CONTRACTOR SHALL BE RESPONSIBLE FOR PROTECTION OF THEIR MATERIAL STOCK PILES AND WORK FROM VANDALISM, EROSION OR UNINTENDED DISTURBANCE DURING THE
- CONSTRUCTION PERIOD AND UNTIL FINAL ACCEPTANCE IS ISSUED. 20. THE CONTRACTOR SHALL KNOW, UNDERSTAND AND ABIDE BY ANY STORM WATER POLLUTION PREVENTION PLAN (SWPPP) ASSOCIATED WITH THE SITE. IF A STORM WATER POLLUTION
- PREVENTION PLAN IS NOT PROVIDED BY THE OWNER'S REPRESENTATIVE, REQUEST A COPY BEFORE PERFORMANCE OF ANY SITE WORK. 21. MAINTAIN ANY STORM WATER MANAGEMENT FACILITIES THAT EXIST ON SITE FOR FULL FUNCTIONALITY. THE CONTRACTOR SHALL INSTALL AND MAINTAIN ANY NEW STORM WATER MANAGEMENT FACILITIES THAT ARE IDENTIFIED IN THE SCOPE OF WORK TO FULL
- FUNCTIONALITY. THE CONTRACTOR SHALL BE RESPONSIBLE FOR ANY FINES OR PENALTIES ASSESSED TO THE OWNER FOR FAILURE TO MAINTAIN STORM WATER MANAGEMENT FACILITIES DURING THE CONTRACT PERIOD. 22. THE CONTRACTOR SHALL PREVENT SEDIMENT, DEBRIS AND ALL OTHER POLLUTANTS FROM
- EXITING THE SITE OR ENTERING THE STORM SEWER SYSTEM DURING ALL DEMOLITION OR CONSTRUCTION OPERATIONS THAT ARE PART OF THIS PROJECT. THE CONTRACTOR SHALL BE RESPONSIBLE FOR ANY FINES OR PENALTIES ASSESSED TO THE OWNER RELATING TO THESE REQUIREMENTS DURING THEIR CONTRACTED COURSE OF WORK. 23. THE CONTRACTOR SHALL BE RESPONSIBLE TO PREVENT ANY IMPACTS TO ADJACENT
- WATERWAYS, WETLANDS, OR OTHER ENVIRONMENTALLY SENSITIVE AREAS RESULTING FROM WORK DONE AS PART OF THIS PROJECT. THE CONTRACTOR SHALL BE RESPONSIBLE FOR ANY FINES OR PENALTIES ASSESSED TO THE OWNER RELATING TO THESE STANDARDS DURING THEIR CONTRACTED COURSE OF WORK.
- 24. THE CONTRACTOR AND/OR THEIR AUTHORIZED AGENTS SHALL ENSURE THAT ALL LOADS OF CONSTRUCTION MATERIAL IMPORTED TO OR EXPORTED FROM THE PROJECT SITE SHALL BE PROPERLY COVERED TO PREVENT LOSS OF MATERIAL DURING TRANSPORT. TRANSPORTATION METHODS ON PUBLIC RIGHT-OF WAYS SHALL CONFORM TO JURISDICTIONAL REQUIREMENTS. THE CONTRACTOR SHALL BE RESPONSIBLE FOR ANY FINES
- OR PENALTIES ASSESSED TO THE OWNER RELATING TO THESE REQUIREMENTS. 25. THE CLEANING OF EQUIPMENT IS PROHIBITED AT THE JOB SITE UNLESS AUTHORIZED BY THE OWNER'S REPRESENTATIVE IN A DESIGNATED AREA. THE DISCHARGE OF WATER, WASTE CONCRETE, POLLUTANTS, OR OTHER MATERIALS SHALL ONLY OCCUR IN AREAS DESIGNED FOR SUCH USE AND APPROVED BY THE OWNER'S REPRESENTATIVE.
- 26. THE CLEANING OF CONCRETE EQUIPMENT IS PROHIBITED AT THE JOB SITE EXCEPT IN

DESIGNATED CONCRETE WASHOUT AREAS. THE DISCHARGE OF WATER CONTAINING WASTE CONCRETE IN THE STORM SEWER IS PROHIBITED.

27. OPEN SPACE SWALES: IF SWALES ARE EXISTING ON SITE AND ARE NOT INTENDED TO BE MODIFIED AS PART OF THE PLANS, THE CONTRACTOR SHALL BE RESPONSIBLE TO MAINTAIN THE CONVEYANCE OF WATER WITHIN THE SWALES DURING THE CONTRACT PERIOD. THE CONTRACTOR SHALL BE RESPONSIBLE FOR ANY DIVERSION OR PUMPING OF WATER IF REQUIRED TO COMPLETE WORK. ANY SWALES DISTURBED BY THE CONTRACTOR SHALL BE REPAIRED/RESTORED TO THEIR ORIGINAL CONDITION. IF THE SWALE NEEDS TO BE

DISTURBED OR MODIFIED FOR ANY REASON, THE CONTRACTOR SHALL NOTIFY THE OWNER'S

28. DETENTION AND WATER QUALITY PONDS: IF DETENTION PONDS AND WATER QUALITY PONDS ARE EXISTING ON SITE AND ARE NOT INTENDED TO BE MODIFIED AS PART OF THE PLANS, THI CONTRACTOR SHALL MINIMIZE DISTURBANCE TO THE PONDS, DRAINAGE STRUCTURES AND SPILLWAYS DURING CONSTRUCTION. ALL PONDS, DRAINAGE STRUCTURES AND SPILLWAYS SHALL BE MAINTAINED IN OPERABLE CONDITIONS AT ALL TIMES. ANY POND OR SPILLWAY AREAS DISTURBED BY THE CONTRACTOR SHALL BE REPAIRED/RESTORED TO THEIR ORIGINAL CONDITION. IF THE POND NEEDS TO BE DISTURBED OR MODIFIED FOR ANY REASON, THE CONTRACTOR SHALL NOTIFY THE OWNER'S REPRESENTATIVE FOR APPROVAL PRIOR TO DISTURBANCE.

REPRESENTATIVE FOR APPROVAL PRIOR TO DISTURBANCE.

- 29. MAINTENANCE ACCESS BENCHES: IF MAINTENANCE BENCHES OR ACCESS ROADS EXIST ON SITE AND ARE NOT INTENDED TO BE MODIFIED AS PART OF THE PLANS, THE CONTRACTOR SHALL MINIMIZE DISTURBANCE TO THE BENCHES OR ACCESS ROADS DURING CONSTRUCTION. ANY BENCHES OR ACCESS ROADS DISTURBED BY THE CONTRACTOR SHALI BE REPAIRED/RESTORED TO THEIR ORIGINAL CONDITION. THE CONTRACTOR SHALL MAINTAIN ACCESS TO ALL EXISTING BENCHES AND ACCESS ROADS DURING THE CONSTRUCTION PERIOD. IF ACCESS NEEDS TO BE BLOCKED FOR ANY REASON, THE CONTRACTOR SHALL NOTIFY THE OWNER'S REPRESENTATIVE FOR APPROVAL PRIOR TO INTERRUPTION OF ACCESS.
- 30. LOCAL, STATE AND FEDERAL JURISDICTIONAL REQUIREMENTS, RESTRICTIONS OR PROCEDURES SHALL SUPERSEDE THESE PLANS, NOTES AND SPECIFICATIONS WHEN MORE STRINGENT. NOTIFY THE OWNER'S REPRESENTATIVE IF CONFLICTS OCCUR.

LAYOUT NOTES

- 1. WRITTEN DIMENSIONS WILL TAKE PRECEDENCE OVER SCALED DIMENSIONS. 2. SHOULD SITE CONDITIONS BE DIFFERENT THAN WHAT IS INDICATED ON THE DRAWINGS
- CONTACT THE LANDSCAPE ARCHITECT IMMEDIATELY FOR CLARIFICATION. 3. CURVED WALKS AND CURB EDGES ARE INTENDED TO BE CONSTRUCTED WITH SMOOTH FLOWING CURVES. ANYTHING OTHER THAN SMOOTH FLOWING CURVES WILL BE REJECTED.
- PERFORM THE PROPOSED WORK. 5. THE CONTRACTOR SHALL PROVIDE A STAKED LAYOUT OF ALL SITE IMPROVEMENTS FOR INSPECTION BY THE OWNER'S REPRESENTATIVE AND MAKE MODIFICATIONS AS REQUIRED AT

4. THE CONTRACTOR SHALL OBTAIN, AT HIS EXPENSE, ALL PERMITS WHICH ARE NECESSARY TO

- NO ADDITIONAL COST TO THE OWNER.
- 6. THE CONTRACTOR SHALL INSTALL SLEEVING FOR IRRIGATION IMPROVEMENTS PRIOR TO INSTALLING CONCRETE FLATWORK. REFER TO IRRIGATION PLANS. 7. LAYOUT WALKS. SCORE JOINTS AND PAVING PATTERNS AS CLOSELY AS POSSIBLE TO PLANS.
- DETAILS, AND SPECIFICATIONS. DO NOT DEVIATE FROM PLANS UNLESS SPECIFIC APPROVAL IS OBTAINED FROM THE OWNER'S REPRESENTATIVE. 8. ALL WORK SHALL BE CONFINED TO THE AREA WITHIN THE CONSTRUCTION LIMITS AS SHOWN ON THE PLANS. ANY AREAS OR IMPROVEMENTS DISTURBED OUTSIDE THESE LIMITS SHALL BE RETURNED TO THEIR ORIGINAL CONDITION AT THE CONTRACTOR'S EXPENSE. IN THE EVENT
- THE CONTRACTOR REQUIRES A MODIFICATION TO THE CONSTRUCTION LIMITS. WRITTEN PERMISSION MUST BE OBTAINED FROM THE LANDSCAPE ARCHITECT PRIOR TO ANY DISTURBANCE OUTSIDE OF THE LIMITS OF WORK. SEE TECHNICAL SPECIFICATIONS.
- 9. CONTRACTOR IS RESPONSIBLE FOR PROVIDING TEMPORARY FENCING AROUND ALL PLAY STRUCTURES UNTIL PROPER FALL SURFACE IS COMPLETELY INSTALLED PER
- MANUFACTURER'S SPECIFICATIONS. 10. CONTRACTOR IS RESPONSIBLE FOR SUPERVISING ALL SAFETY SURFACING AND PAVEMENT DURING THE CURING PROCESS.

EROSION NOTES

- 1. THE OWNER, SITE DEVELOPER, CONTRACTOR AND/OR THEIR AUTHORIZED AGENTS SHALL REMOVE ALL SEDIMENT, MUD, AND CONSTRUCTION DEBRIS THAT MAY ACCUMULATE IN THE FLOW LINE AND THE PUBLIC RIGHTS-OF-WAY OF THE TOWN OF DILLON AS A RESULT OF THIS SITE DEVELOPMENT. SAID REMOVAL SHALL BE CONDUCTED IN A TIMELY MANNER.
- 2. THE CONTRACTOR SHALL PREVENT SEDIMENT, DEBRIS AND ALL OTHER POLLUTANTS FROM ENTERING THE STORM SEWER SYSTEM DURING ALL DEMOLITION OR CONSTRUCTION
- OPERATIONS THAT ARE PART OF THIS PROJECT. 3. THE CONTRACTOR SHALL BE HELD RESPONSIBLE FOR REMEDIATION OF ANY ADVERSE
- PART OF THIS PROJECT. 4. THE DEVELOPER, GENERAL CONTRACTOR, GRADING CONTRACTOR AND/OR THEIR AUTHORIZED AGENTS SHALL ENSURE THAT ALL LOADS OF CUT AND FILL MATERIAL IMPORTED TO OR EXPORTED FROM THIS SITE SHALL BE PROPERLY COVERED TO PREVENT
- LOSS OF MATERIAL DURING TRANSPORT ON PUBLIC RIGHT-OF WAYS. 5. THE USE OF REBAR, STEEL STAKES, OR STEEL FENCE POSTS TO STAKE DOWN STRAW OR
- HAY BALES OR TO SUPPORT SILT FENCING USED AS AN EROSION CONTROL MEASURE IS PROHIBITED. 6. THE CLEANING OF CONCRETE TRUCK DELIVERY CHUTES IS PROHIBITED AT THE JOB SITE.
- SYSTEM IS PROHIBITED. 7. THE CONTRACTOR SHALL PROTECT ALL STORM SEWER FACILITIES ADJACENT TO ANY LOCATION WHERE PAVEMENT CUTTING OPERATIONS INVOLVING WHEEL CUTTING, SAW
- IMPACTS TO ADJACENT WATERWAYS, WETLANDS, ETC., RESULTING FROM WORK DONE AS

- THE DISCHARGE OF WATER CONTAINING WASTE CONCRETE TO THE STORM SEWER
- CUTTING, OR ABRASIVE WATER JET CUTTING ARE TO TAKE PLACE. THE CONTRACTOR SHALL REMOVE AND PROPERLY DISPOSE OF ALL WASTE PRODUCTS GENERATED BY SAID CUTTING OPERATIONS ON A DAILY BASIS.

LANDSCAPE NOTES

- 1. THE CONTRACTOR SHALL FOLLOW THE LANDSCAPE PLANS AND SPECIFICATIONS AS CLOSELY AS POSSIBLE. ANY SUBSTITUTION OR ALTERATION SHALL NOT BE ALLOWED WITHOUT APPROVAL OF THE OWNER'S REPRESENTATIVE. OVERALL PLANT QUANTITY AND
- QUALITY SHALL BE CONSISTENT WITH THE PLANS. 2. THE CONTRACTOR IS RESPONSIBLE FOR VERIFYING ALL PLANT QUANTITIES. GRAPHIC QUANTITIES TAKES PRECEDENCE OVER WRITTEN QUANTITIES.
- 3. THE OWNER'S REPRESENTATIVE RESERVES THE RIGHT TO INSPECT AND TAG ALL PLANT MATERIAL PRIOR TO SHIPPING TO THE SITE. IN ALL CASES, THE OWNER'S REPRESENTATIVE MAY REJECT PLANT MATERIAL AT THE SITE IF MATERIAL IS DAMAGED, DISEASED, OR DECLINING IN HEALTH AT THE TIME OF ONSITE INSPECTIONS OR IF THE PLANT MATERIAL DOES NOT MEET THE MINIMUM SPECIFIED STANDARD IDENTIFIED ON THE PLANS AND IN THE SPECIFICATIONS. THE CONTRACTOR SHALL COORDINATE WITH THE OWNER'S REPRESENTATIVE FOR INSPECTION AND APPROVAL OF ALL MATERIALS AND PRODUCTS
- 4. THE OWNER'S REPRESENTATIVE MAY ELECT TO UPSIZE PLANT MATERIAL AT THEIR DISCRETION BASED ON SELECTION, AVAILABILITY, OR TO ENHANCE SPECIFIC AREAS OF THE PROJECT. THE CONTRACTOR SHALL VERIFY PLANT MATERIAL SIZES WITH OWNER'S REPRESENTATIVE PRIOR TO PURCHASING, SHIPPING OR STOCKING OF PLANT MATERIALS. SUBMIT CHANGE ORDER REQUEST TO OWNER'S REPRESENTATIVE FOR APPROVAL IF ADDITIONAL COST IS REQUESTED BY THE CONTRACTOR PRIOR TO INSTALLATION. RE-STOCKING CHARGES WILL NOT BE APPROVED IF THE CONTRACTOR FAILS TO SUBMIT A REQUEST FOR MATERIAL CHANGES.
- THE CONTRACTOR SHALL WARRANTY ALL CONTRACTED WORK AND MATERIALS FOR A PERIOD OF ONE YEAR AFTER SUBSTANTIAL COMPLETION HAS BEEN ISSUED BY THE OWNER'S REPRESENTATIVE FOR THE ENTIRE PROJECT UNLESS OTHERWISE SPECIFIED I
- THE CONTRACT DOCUMENTS OR SPECIFICATIONS. 6. REFER TO IRRIGATION PLANS FOR LIMITS AND TYPES OF IRRIGATION DESIGNED FOR THE LANDSCAPE. IN NO CASE SHALL IRRIGATION BE EMITTED WITHIN THE MINIMUM DISTANCE FROM BUILDING OR WALL FOUNDATIONS AS STIPULATED IN THE GEOTECHNICAL REPORT. ALL IRRIGATION DISTRIBUTION LINES, HEADS AND EMITTERS SHALL BE KEPT OUTSIDE THE MINIMUM DISTANCE AWAY FROM ALL BUILDING AND WALL FOUNDATIONS AS STIPULATED IN THE GEOTECHNICAL REPORT.
- 7. LANDSCAPE MATERIAL LOCATIONS SHALL HAVE PRECEDENCE OVER IRRIGATION MAINLINE AND LATERAL LOCATIONS. COORDINATE INSTALLATION OF IRRIGATION EQUIPMENT SO THAT IT DOES NOT INTERFERE WITH THE PLANTING OF TREES OR OTHER LANDSCAPE MATERIAL.
- THE LANDSCAPE CONTRACTOR SHALL BE RESPONSIBLE FOR ENSURING POSITIVE DRAINAGE EXISTS IN ALL LANDSCAPE AREAS. SURFACE DRAINAGE ON LANDSCAPE AREAS SHALL NOT FLOW TOWARD STRUCTURES AND FOUNDATIONS. MAINTAIN SLOPE AWAY FROM FOUNDATIONS PER THE GEOTECHNICAL REPORT RECOMMENDATIONS. ALL LANDSCAPE AREAS BETWEEN WALKS AND CURBS SHALL DRAIN FREELY TO THE CURB UNLESS OTHERWISE IDENTIFIED ON THE GRADING PLAN. IN NO CASE SHALL THE GRADE, TURF THATCH, OR OTHER LANDSCAPE MATERIALS DAM WATER AGAINST WALKS. MINIMUM SLOPES ON LANDSCAPE AREAS SHALL BE 2%; MAXIMUM SLOPE SHALL BE 25% UNLESS SPECIFICALLY IDENTIFIED ON THE PLANS OR APPROVED BY THE OWNER'S REPRESENTATIVE.
- 9. PRIOR TO INSTALLATION OF PLANT MATERIALS, AREAS THAT HAVE BEEN COMPACTED OR DISTURBED BY CONSTRUCTION ACTIVITY SHALL BE THOROUGHLY LOOSENED TO A DEPTH OF 8' - 12' AND AMENDED PER SPECIFICATIONS.
- 10. ALL LANDSCAPED AREAS ARE TO RECEIVE ORGANIC SOIL PREPARATION AT AS NOTED IN THE TECHNICAL SPECIFICATIONS.
- 11. TREES SHALL NOT BE LOCATED IN DRAINAGE SWALES, DRAINAGE AREAS, OR UTILITY EASEMENTS. CONTACT OWNER'S REPRESENTATIVE FOR RELOCATION OF PLANTS IN QUESTIONABLE AREAS PRIOR TO INSTALLATION.
- 12. THE CENTER OF EVERGREEN TREES SHALL NOT BE PLACED CLOSER THAN 8' AND THE CENTER OF ORNAMENTAL TREES CLOSER THAN 6' FROM A SIDEWALK, STREET OR DRIVE LANE. EVERGREEN TREES SHALL NOT BE LOCATED ANY CLOSER THAN 15' FROM IRRIGATION ROTOR HEADS. NOTIFY OWNER'S REPRESENTATIVE IF TREE LOCATIONS CONFLICT WITH THESE STANDARDS FOR FURTHER DIRECTION.
- 13. ALL EVERGREEN TREES SHALL BE FULLY BRANCHED TO THE GROUND AND SHALL NOT EXHIBIT SIGNS OF ACCELERATED GROWTH AS DETERMINED BY THE OWNER'S
- REPRESENTATIVE. 14. ALL TREES ARE TO BE STAKED AND GUYED PER DETAILS FOR A PERIOD OF 3 YEARS. THE CONTRACTOR SHALL BE RESPONSIBLE FOR REMOVING STAKES AT THE END OF 3 YEARS FROM ACCEPTANCE OF LANDSCAPE INSTALLATION BY THE OWNER'S REPRESENTATIVE.
- OBTAIN APPROVAL BY OWNER'S REPRESENTATIVE PRIOR TO REMOVAL. 15. ALL TREES INSTALLED ABOVE RETAINING WALLS UTILIZING GEO-GRID MUST BE HAND DUG TO PROTECT GEO-GRID. IF GEO-GRID MUST BE CUT TO INSTALL TREES, APPROVAL MUST BE
- GIVEN BY OWNER'S REPRESENTATIVE PRIOR TO DOING WORK. 16. ALL TREES IN SEED OR TURF AREAS SHALL RECEIVE MULCH RINGS. OBTAIN APPROVAL FROM OWNER'S REPRESENTATIVE FOR ANY TREES THAT WILL NOT BE MULCHED FOR
- EXCESSIVE MOISTURE REASONS. 17. SHRUB, GROUNDCOVER AND PERENNIAL BEDS ARE TO BE CONTAINED BY SPADE CUT OR STEEL EDGER, REFER TO PLANS. EDGER IS NOT REQUIRED WHEN ADJACENT TO
- CURBS, WALLS, WALKS OR SOLID FENCES WITHIN 3' OF PRE-MULCHED FINAL GRADE. EDGER SHALL NOT BE REQUIRED TO SEPARATE MULCH TYPES UNLESS SPECIFIED ON THE PLANS.
- 18. ALL SHRUB BEDS ARE TO BE MULCHED WITH SHREDDED WOOD LANDSCAPE MULCH OVER SPECIFIED GEOTEXTILE WEED CONTROL FABRIC. ALL GROUND COVER AND PERENNIAL FLOWER BEDS SHALL BE MULCHED WITH SMALL NUGGET WOOD LANDSCAPE MULCH. NO
- WEED CONTROL FABRIC IS REQUIRED IN GROUNDCOVER OR PERENNIAL AREAS. 19. AT SEED AREA BOUNDARIES ADJACENT TO EXISTING NATIVE AREAS, OVERLAP ABUTTING NATIVE AREAS BY THE FULL WIDTH OF THE SEEDER.
- 20. DISTURBED NATIVE AREAS WHICH ARE TO REMAIN SHALL BE OVER SEEDED AND RESTORED WITH SPECIFIED SEED MIX.
- 21. CONTRACTOR SHALL OVER SEED ALL MAINTENANCE OR SERVICE ACCESS BENCHES AND ROADS WITH SPECIFIED SEED MIX UNLESS OTHERWISE NOTED ON THE PLANS.
- 22. ALL SEEDED SLOPES EXCEEDING 25% IN GRADE (4:1) SHALL RECEIVE EROSION CONTROL BLANKETS. PRIOR TO INSTALLATION, NOTIFY OWNER'S REPRESENTATIVE FOR APPROVAL OF LOCATION AND ANY ADDITIONAL COST IF A CHANGE ORDER IS NECESSARY.
- 23. WHEN COMPLETE, ALL GRADES SHALL BE WITHIN +/- 1/8" OF FINISHED GRADES AS SHOWN ON THE PLANS. 24. PRIOR TO THE PLACEMENT OF MULCH AND WEED FABRIC, A GRANULAR, PRE-EMERGENT,
- WEED CONTROL AGENT SHALL BE ADDED TO ALL PLANTING BEDS IN ACCORDANCE WITH THE MANUFACTURER'S INSTRUCTION. EXCEPT AROUND ORNAMENTAL GRASSES.
- 25. THE CONTRACTOR IS EXPECTED TO KNOW AND UNDERSTAND THE TOWN AND COUNTY SPECIFICATIONS FOR LANDSCAPE AND IRRIGATION. IN CASES OF DISCREPANCIES THE HIGHER OF THE TWO STANDARDS SHALL HAVE PRECEDENCE. 26. THE DEVELOPER, HIS SUCCESSORS AND ASSIGNS SHALL BE RESPONSIBLE FOR THE

INSTALLATION, MAINTENANCE AND REPLACEMENT OF ALL IMPROVEMENTS SHOWN OR

INDICATED ON THE APPROVED LANDSCAPE PLAN ON FILE IN THE PLANNING DEPARTMENT.

SHEET INDEX

LANDSCAPE NOTES L-101 LANDSCAPE PLAN SNOW STORAGE PLAN L-201 LANDSCAPE DETAILS

VICINITY MAP



ARCHITECTS

2901 Blake Street, Suite 100 Denver, CO 80205 303.861.8555

NORRIS DESIGN Planning | Landscape Architecture | Branding


> P.O. Box 2320 Frisco, CO 80443 P 970.485.4478 www.norris-design.com

409 Main Street, Suite 207



Original Issuance PUD DEVELOPMENT 07/23/2019 PLAN - REVISED

Project Information

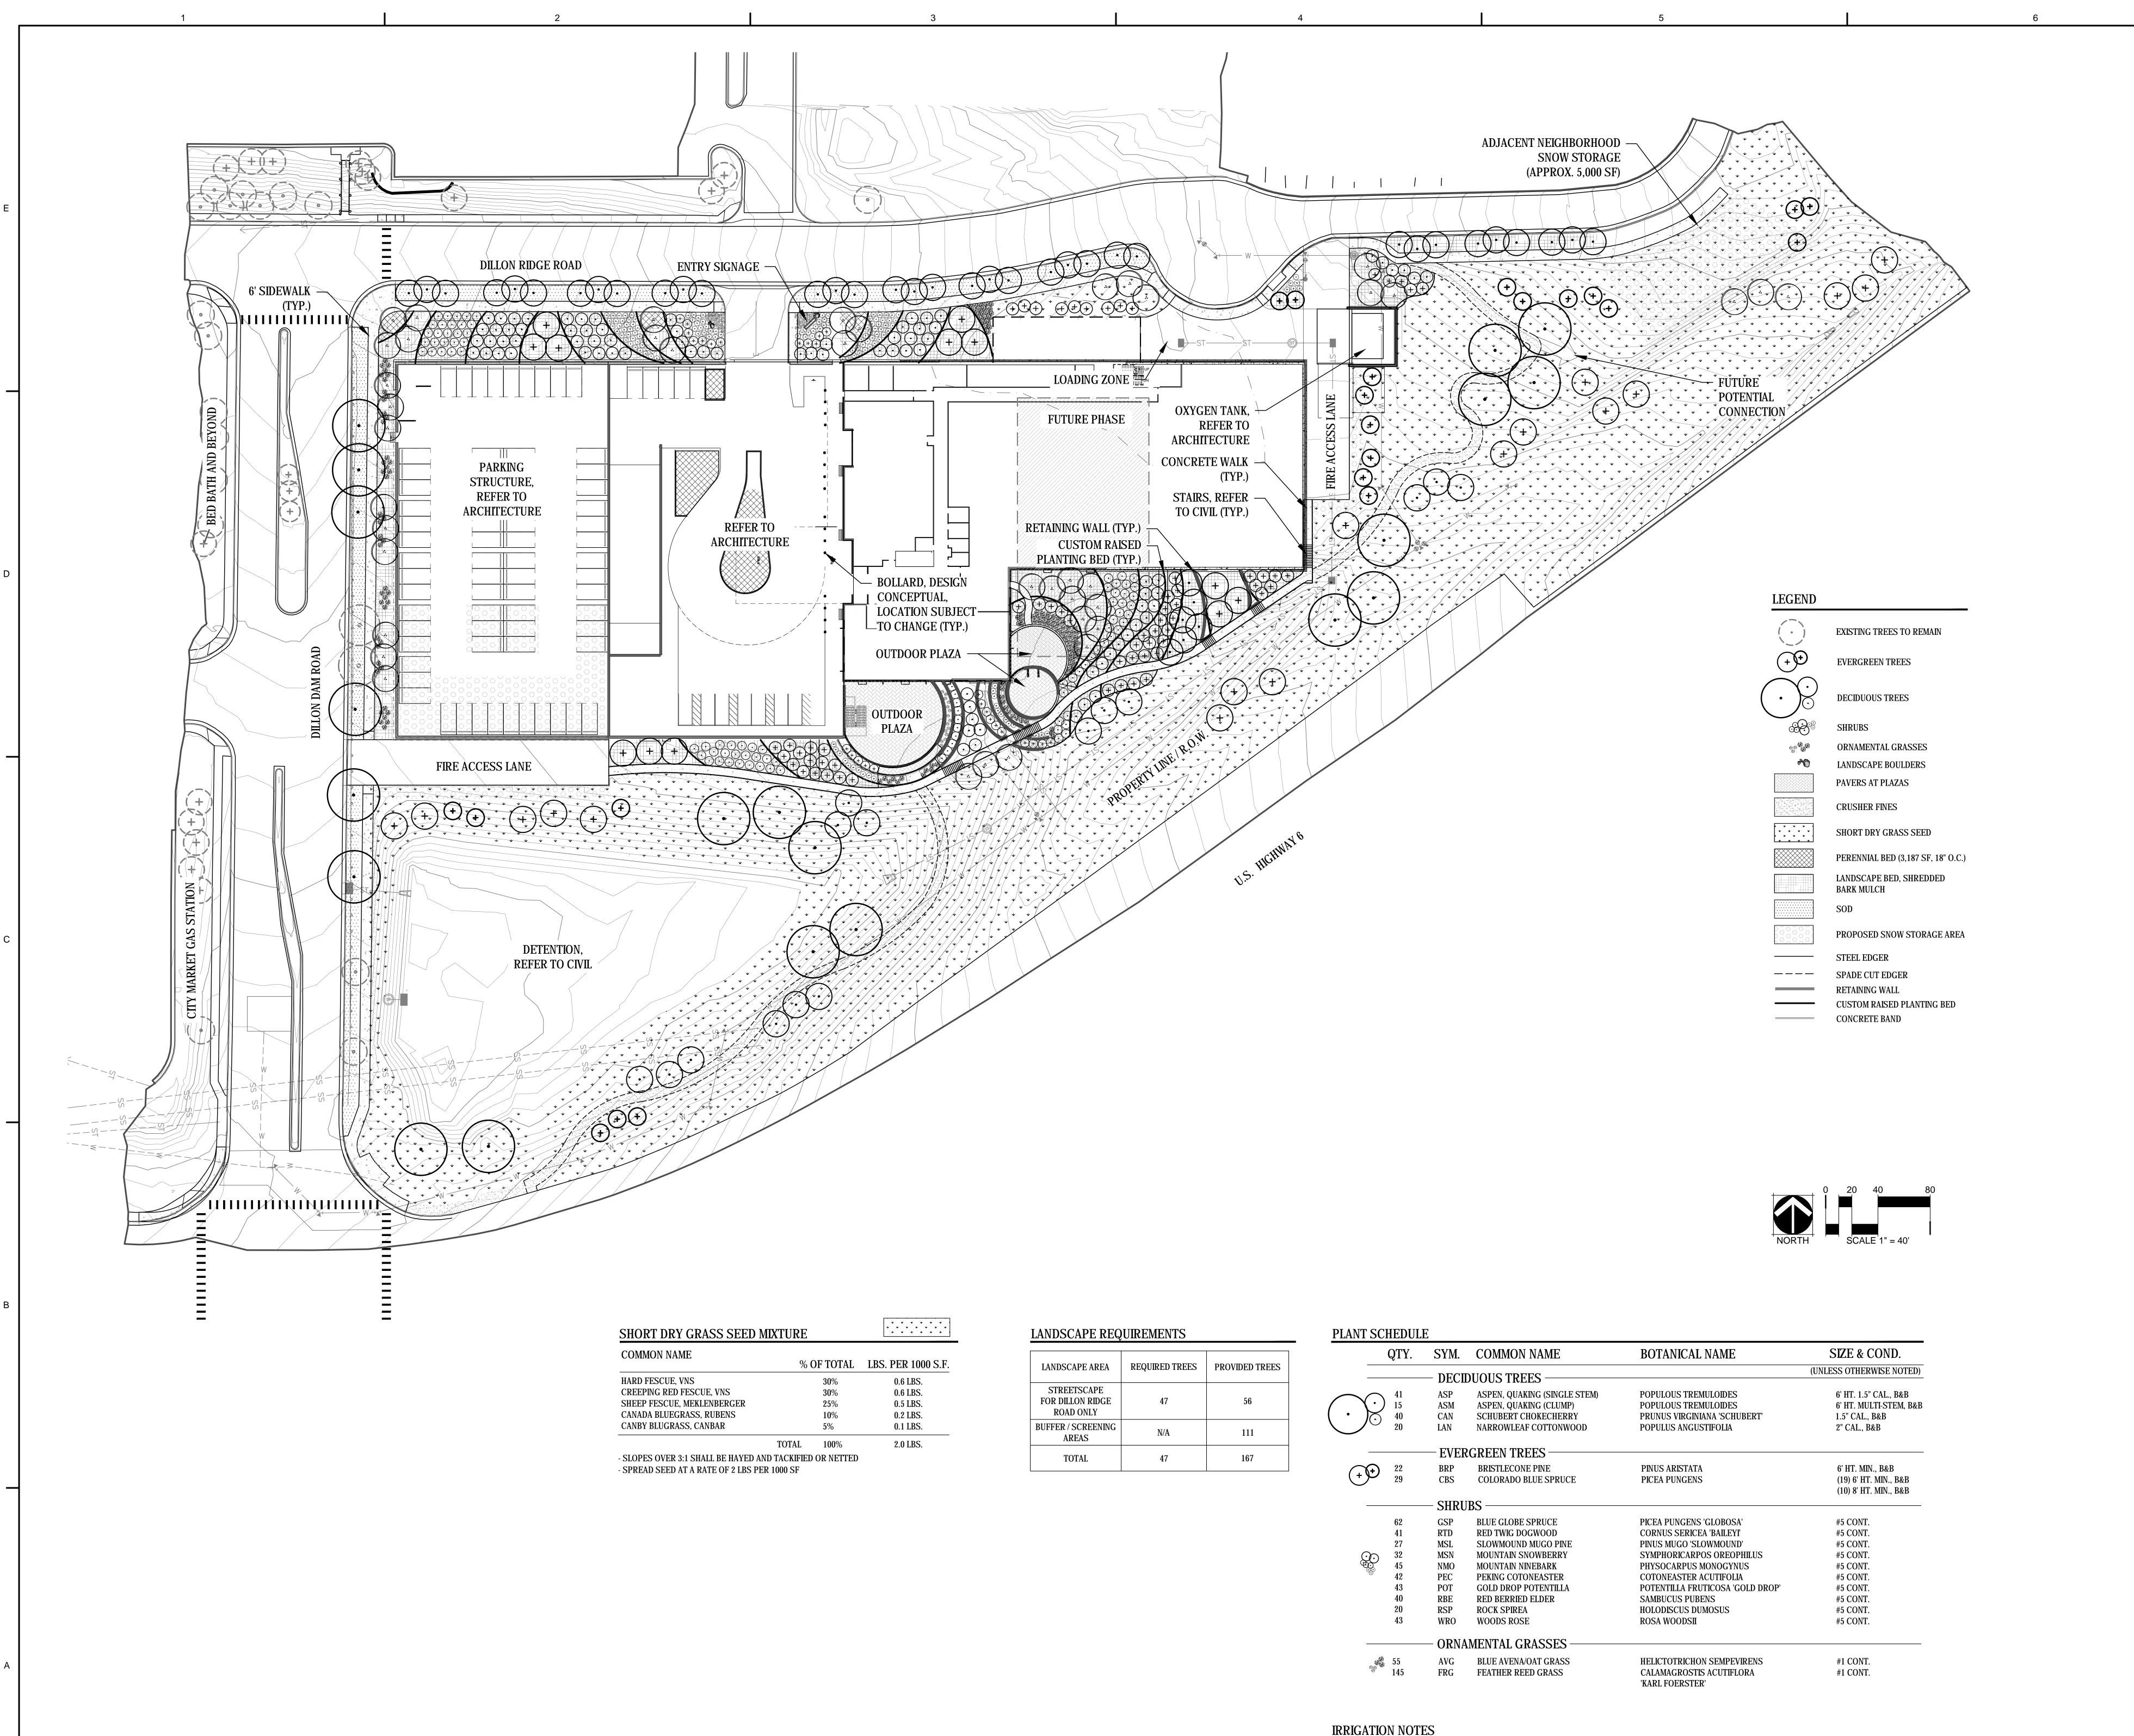

PARTNERSHIP ARCHITECTS

2901 Blake Street, Suite 100 Denver, CO 80205 303.861.8555

409 Main Street, Suite 207 P.O. Box 2320 Frisco, CO 80443 P 970.485.4478 www.norris-design.com



PUD DEVELOPMENT PLAN - REVISED

Project Information

LANDSCAPE


DPA Project:


Sheet Number:

1. ALL TREES, SHRUBS, ORNAMENTAL GRASSES AND PERENNIALS SHALL BE IRRIGATED. 1.1. ALL TREES, SHRUBS AND ORNAMENTAL GRASSES TO BE DRIP IRRIGATED. 1.2. ALL PERENNIALS TO BE SPRAY IRRIGATED.

SCHEMATIC DESIGN NOTES

SCHEMATIC DESIGN ONLY, SUBJECT TO CHANGE. 2. NOT INTENDED FOR PRICING OR CONSTRUCTION.

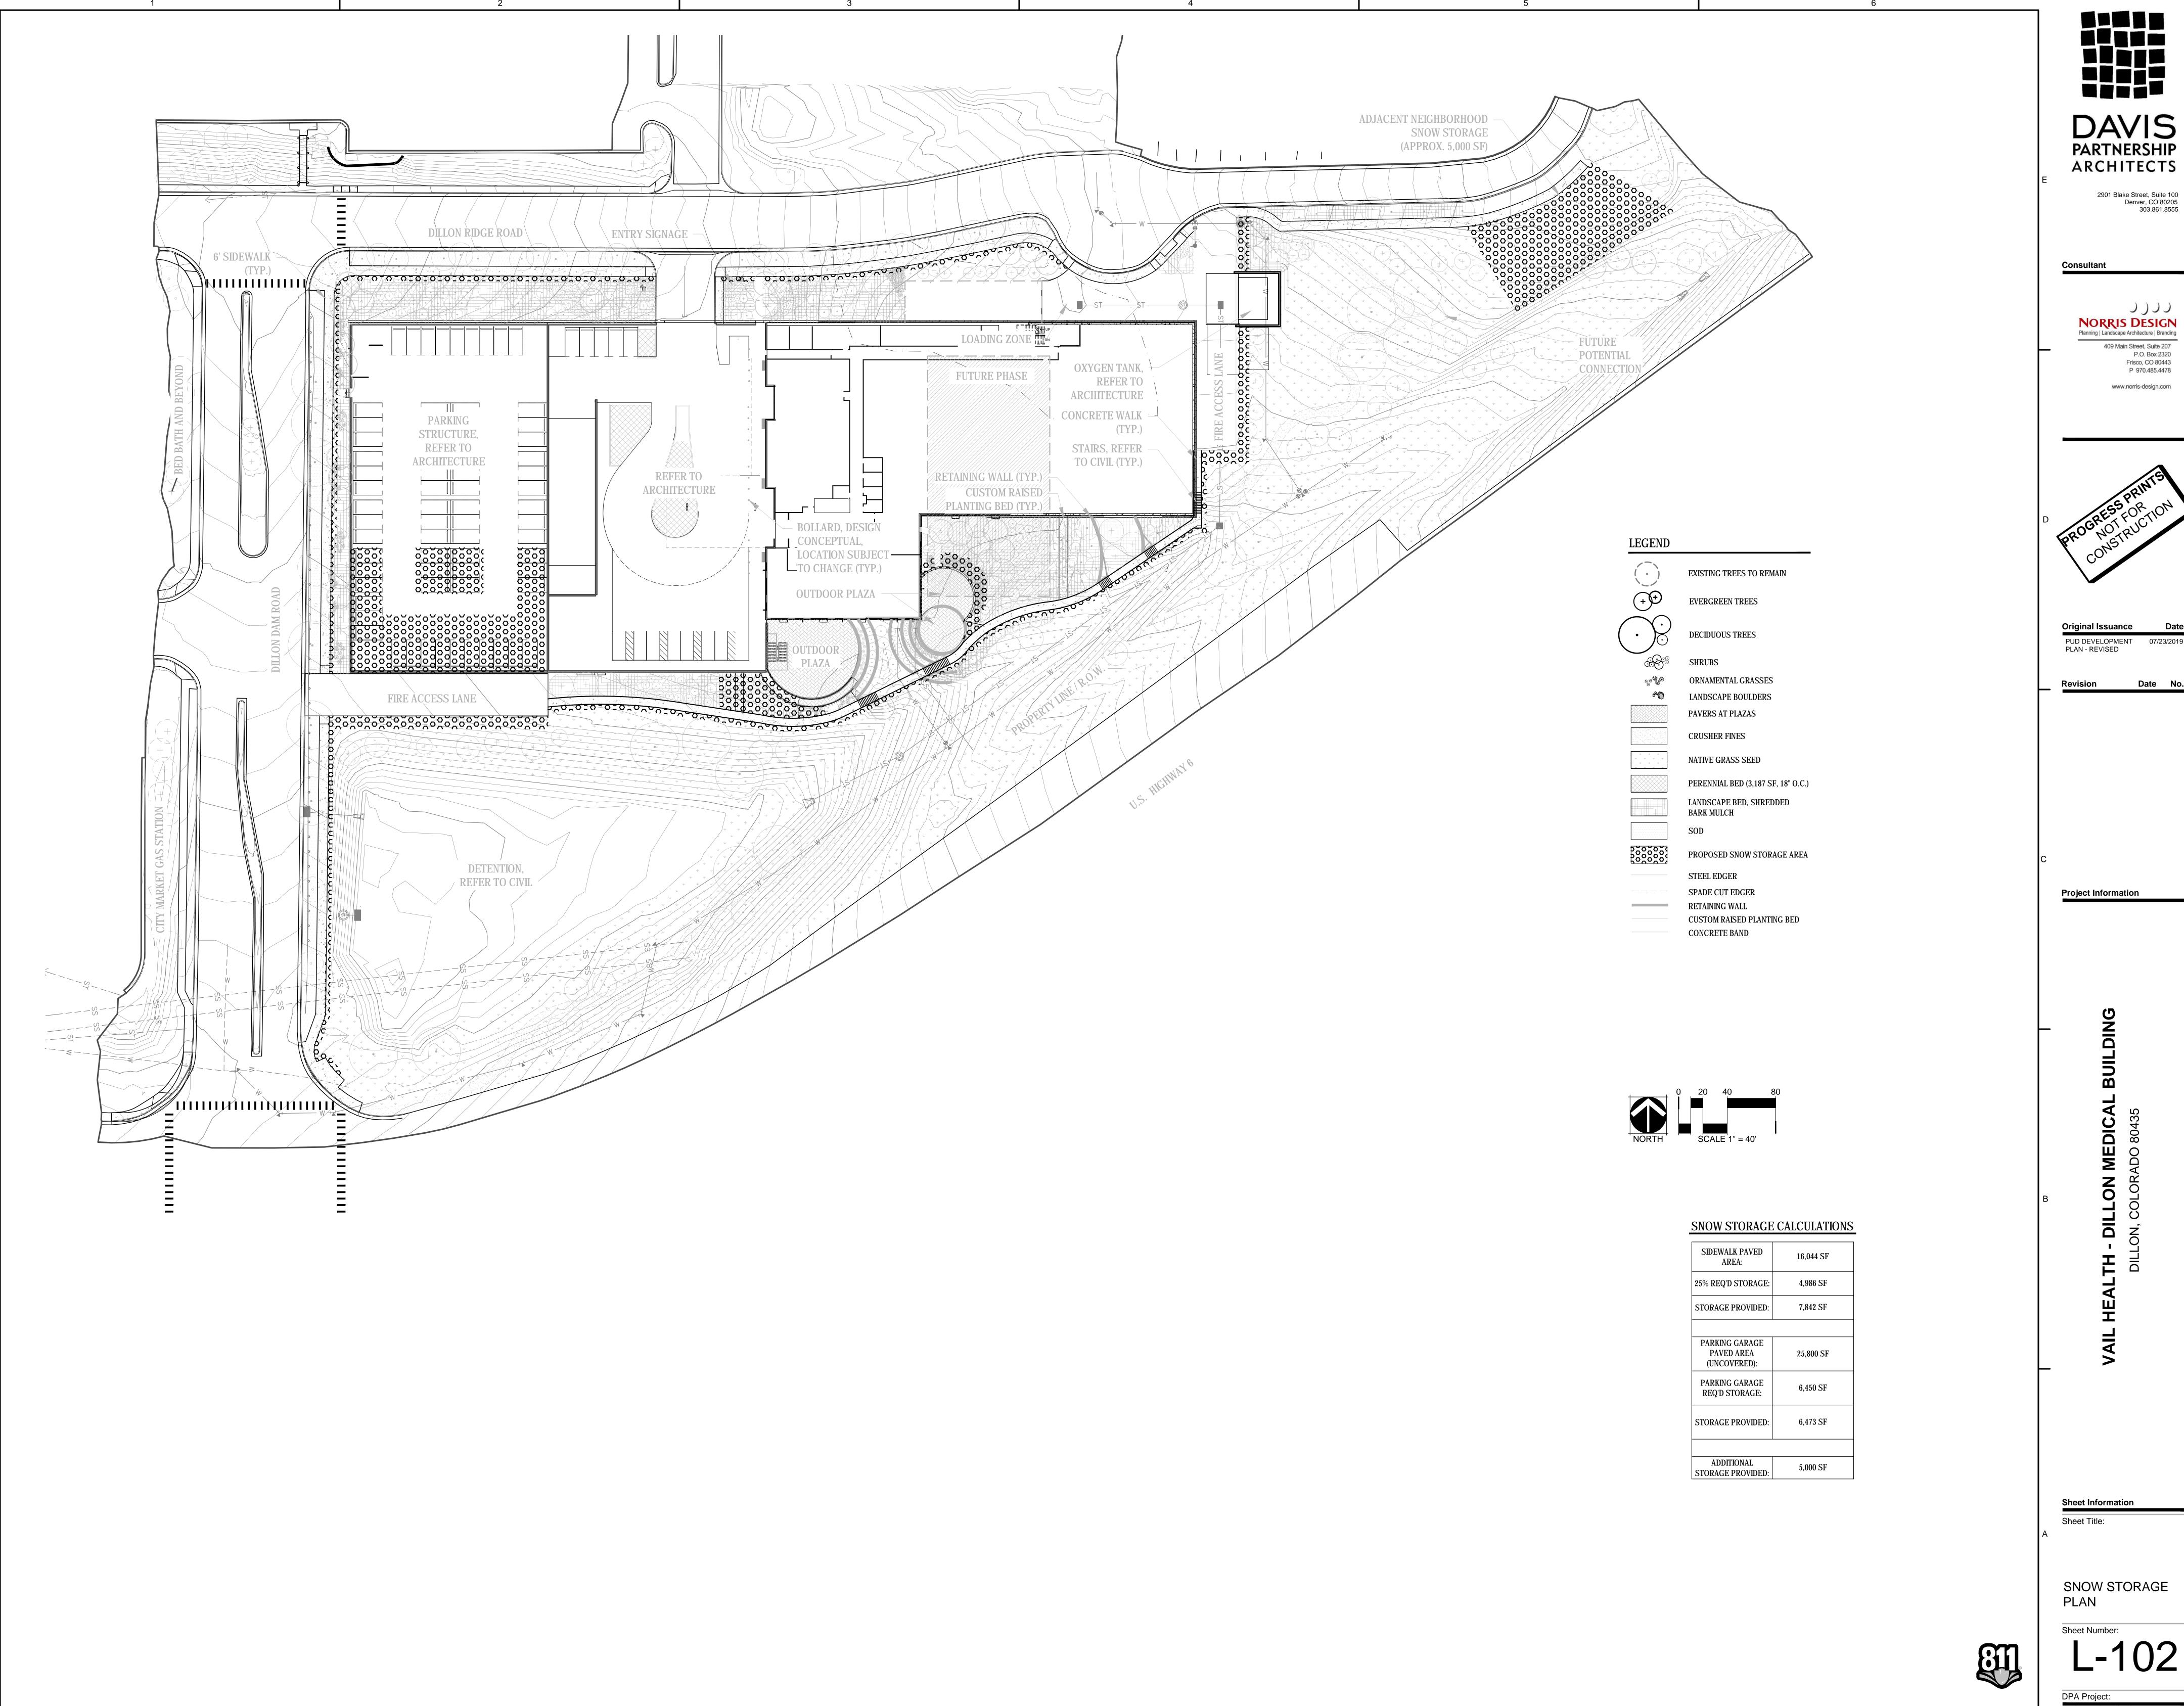

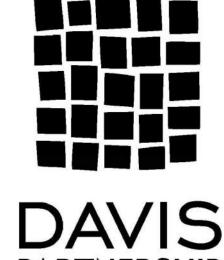

409 Main Street, Suite 207

P.O. Box 2320 Frisco, CO 80443

P 970.485.4478

www.norris-design.com

DAVIS
PARTNERSHIP
ARCHITECTS

TYPICALLY IRRIGATED
TURFGRASS OR DRYLAND SEED

VERTICAL SPADE CUT EDGE FILLED WITH SPECIFIED MULCH, TAPER EDGE OF BED SO MULCH IS DEEPER AGAINST SPADED

(3) SPECIFIED DEPTH OF MULCH (TYPICALLY WOOD MULCH 3"-4" DEEP)

4 PLANTING BED

IRRIGATION HEADS SHOULD BE LOCATED ADJACENT TO MULCH BEDS, OFFSET HEAD INTO GRASS AREA TO ENSURE STABLE SUPPORT.

NOTE:

1. IF IRRIGATION HEAD IS LOCATED ADJACENT TO MULCH BEDS, OFFSET HEAD INTO GRASS AREA TO ENSURE STABLE SUPPORT.

7 SPADE CUT EDGE

SCALE: 1/2" = 1'-0"

DAVIS
PARTNERSHIP
ARCHITECTS

2901 Blake Street, Suite 100 Denver, CO 80205 303.861.8555

`oncultant

NORRIS DESIGN
Planning | Landscape Architecture | Branding
409 Main Street, Suite 207

P.O. Box 2320 Frisco, CO 80443

P 970.485.4478

www.norris-design.com

OGRESS FOR TON

Original Issuance Dat
PUD DEVELOPMENT 07/23/2019

Revision Date N

PLAN - REVISED

Project Information

EALTH - DILLON MEDICAL BUILDI DILLON, COLORADO 80435


Sheet Information
Sheet Title:

DETAILS

Sheet Number:

LANDSCAPE

L-201

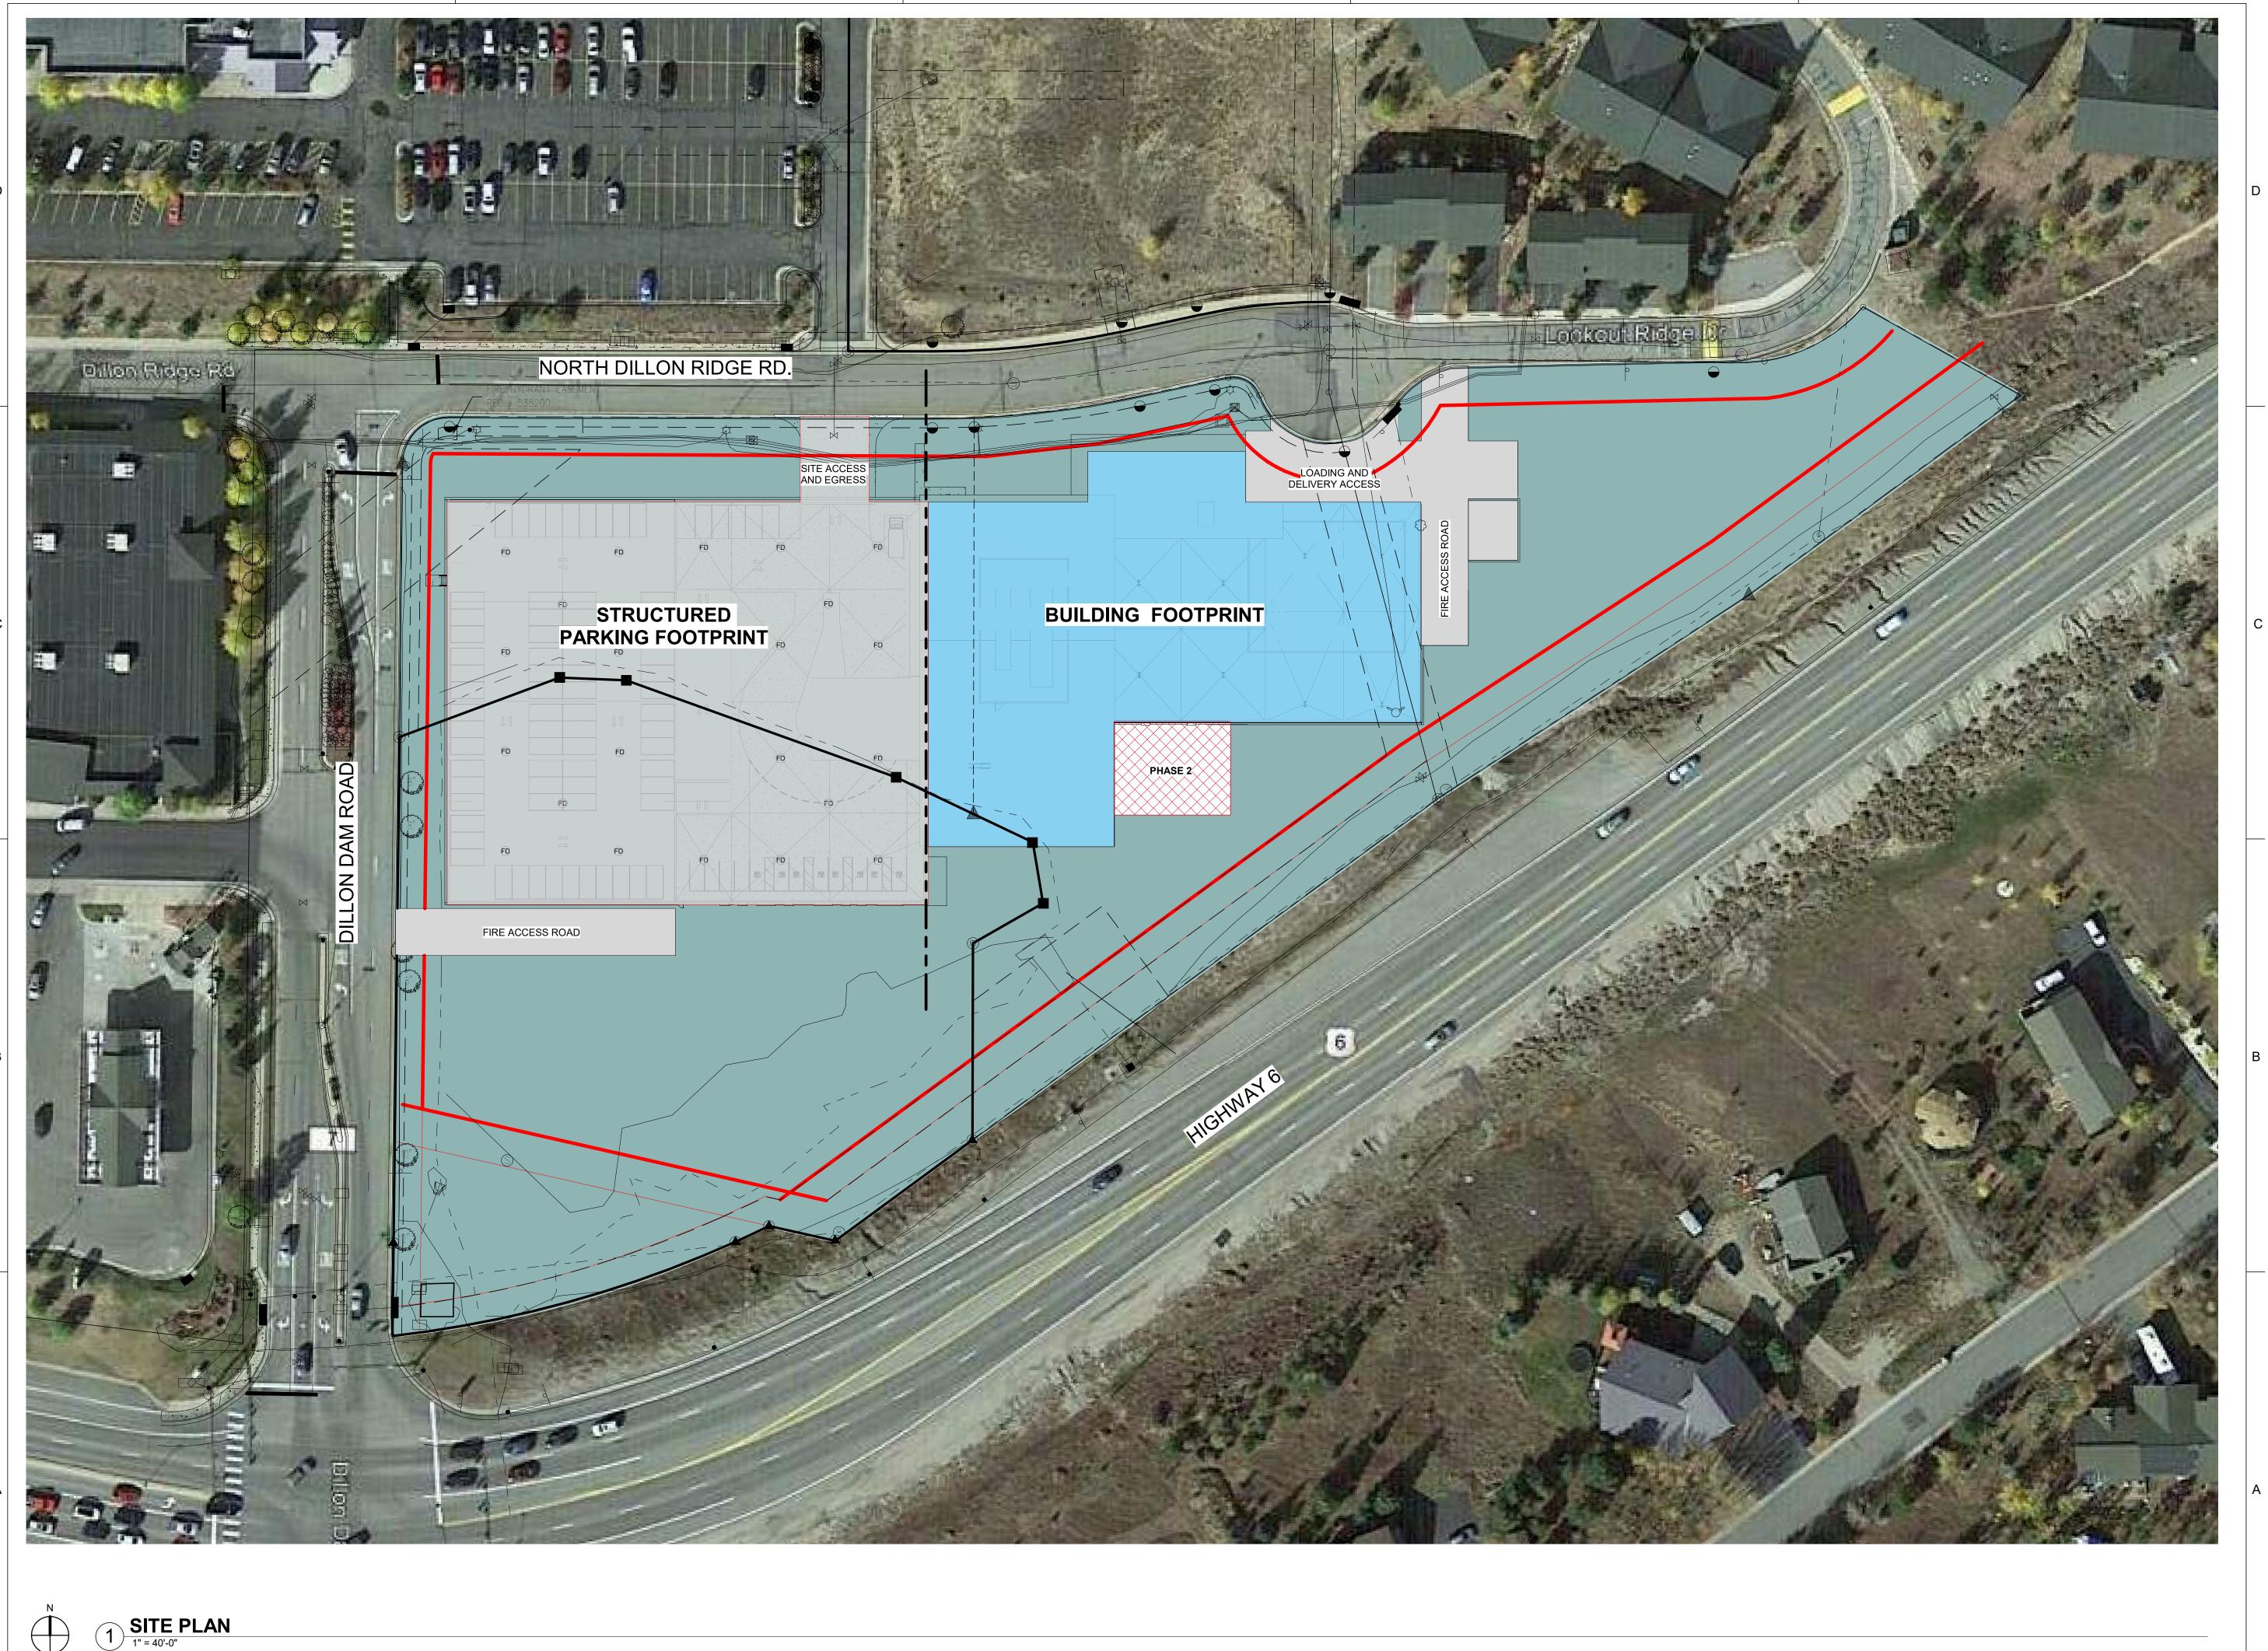

PARTNERSHIP ARCHITECTS DENVER OFFICE 2901 Blake Street, Suite 100 Denver, CO 80205 303.861.8555

Consultant



Original Issuance PUD DEVELOPMENT PLAN - REVISED

Revisions

Project Information


VAIL HEALTH - DILLON MEDICAL BUILDING DILLON, COLORADO 80435

Sheet Information

Sheet Title:
ARCHITECTURAL
SITE PLAN

Sheet Number:



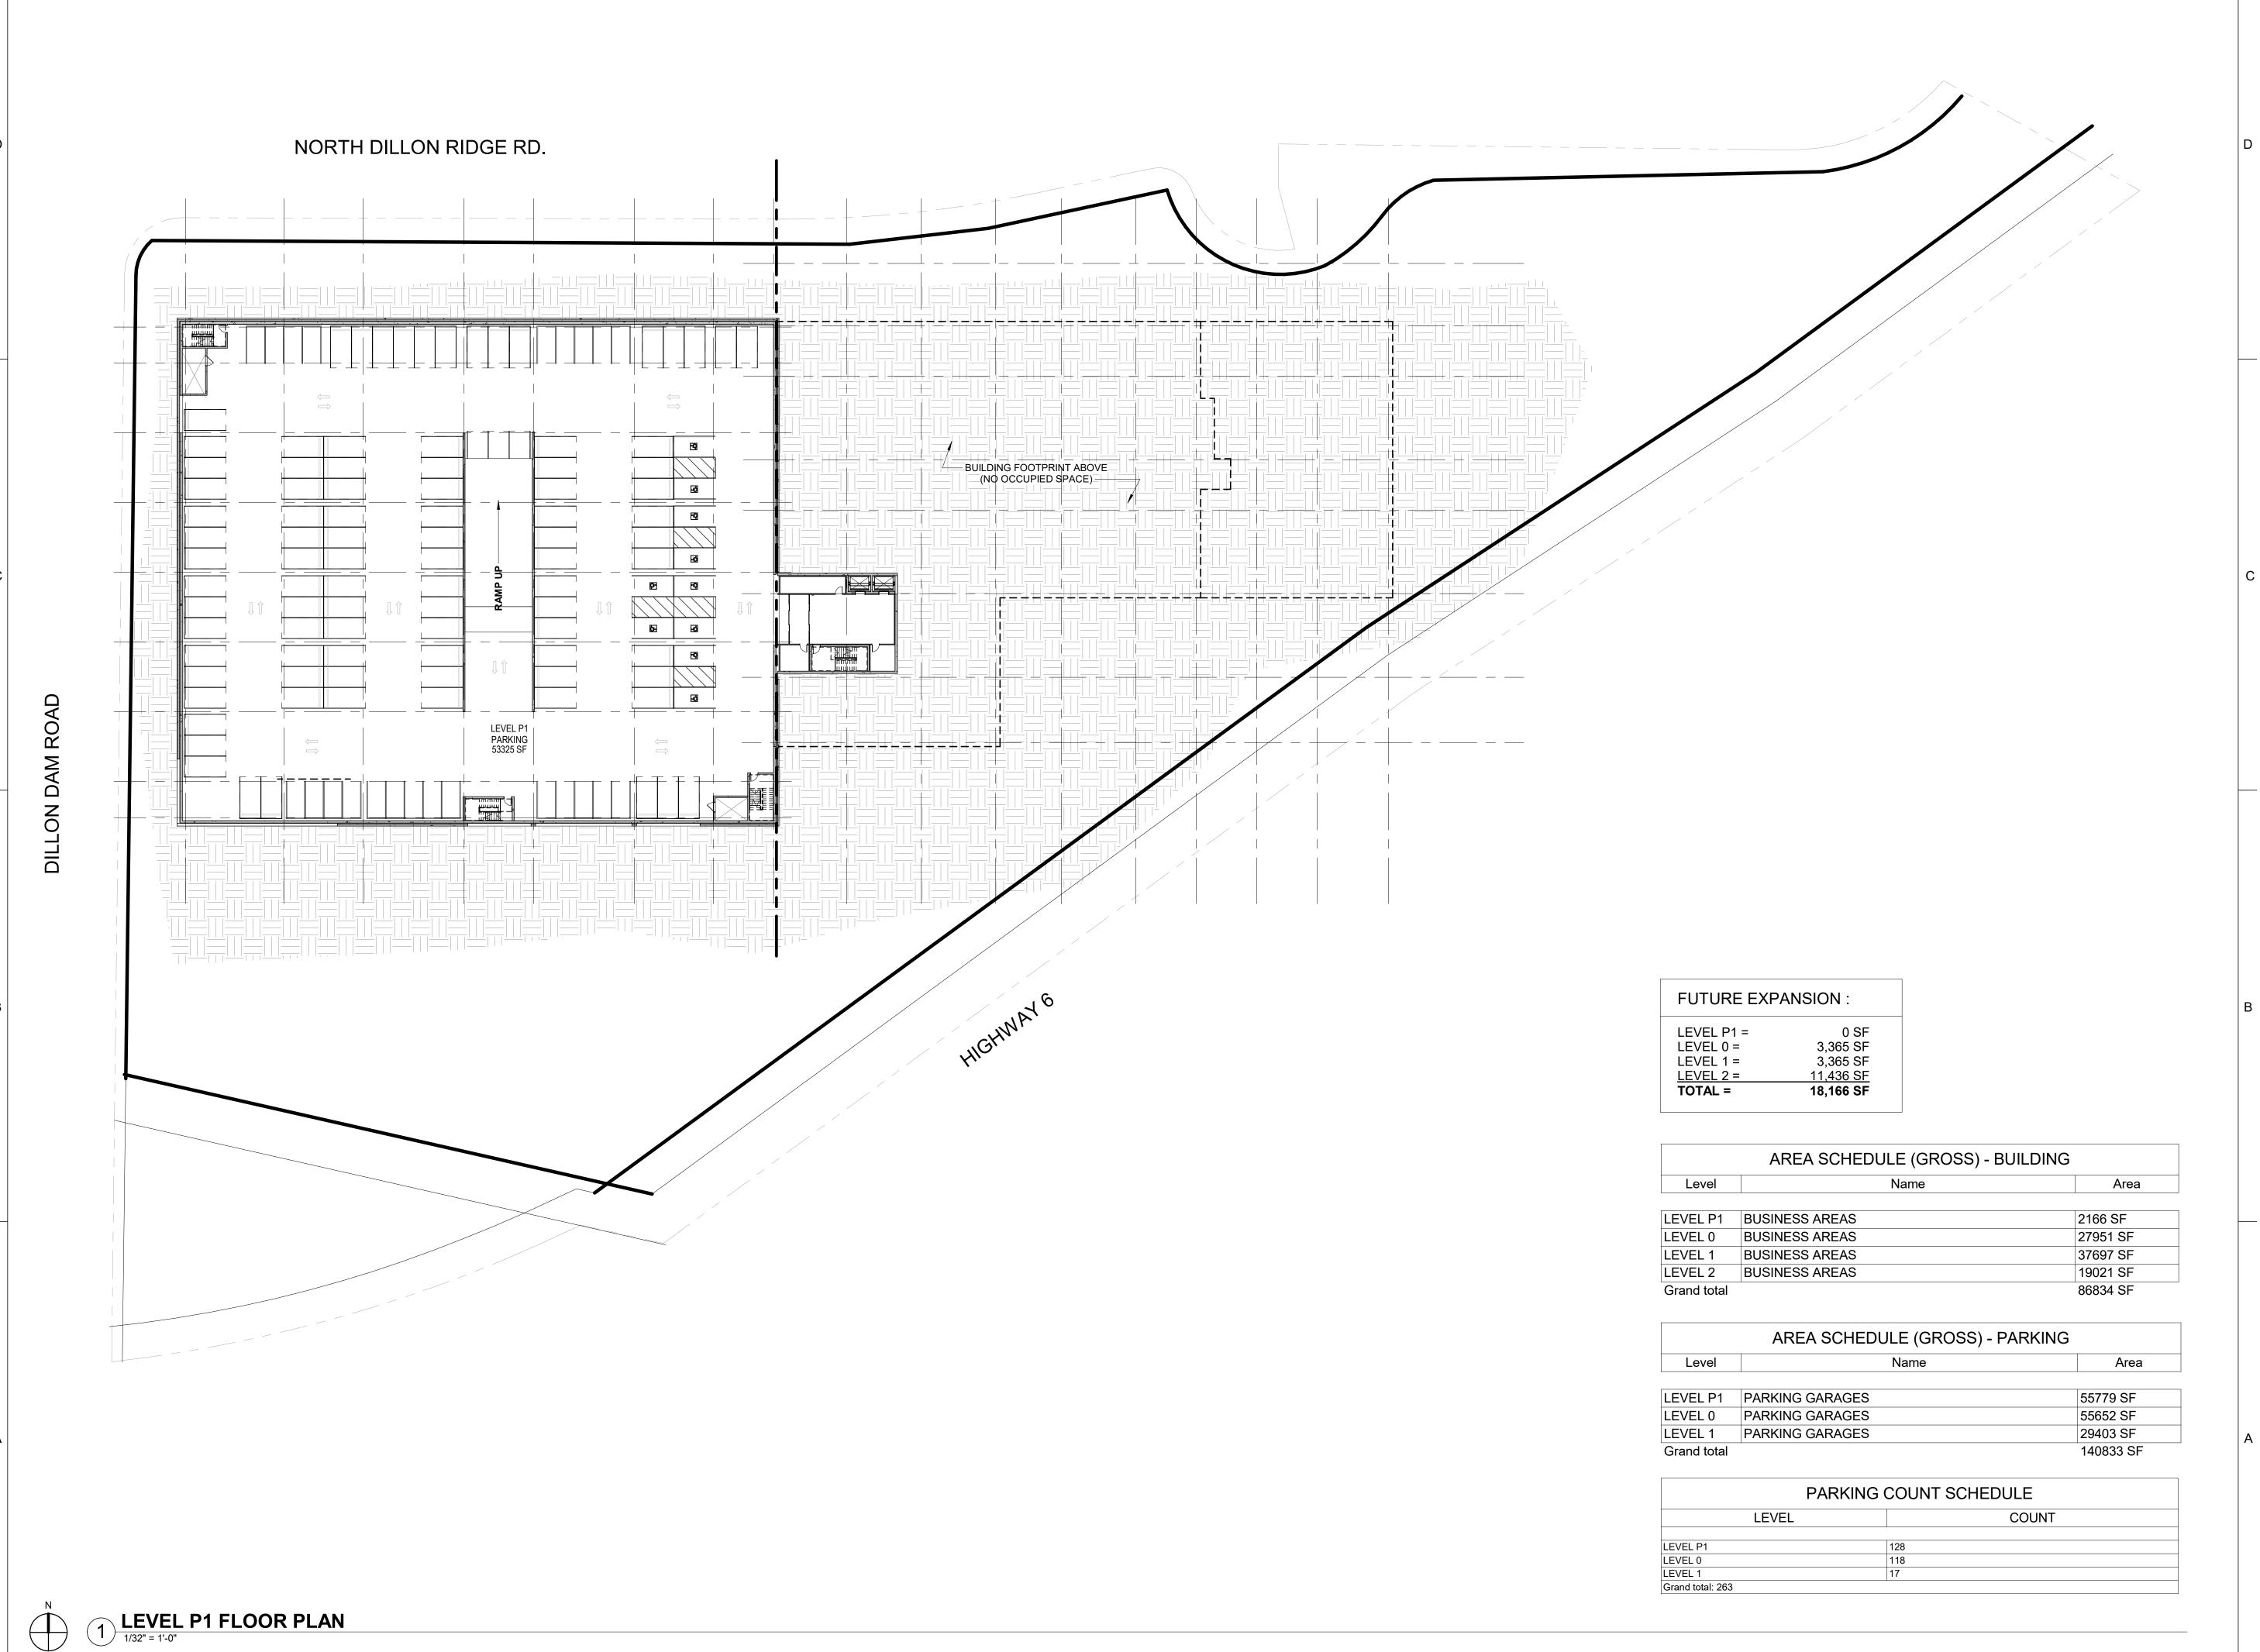



PROGRESS PRINTS

PROGRESS PRINTS

CONSTRUCTON

CONSTRUCTON

Original IssuanceDatePUD DEVELOPMENT
PLAN - REVISED07/23/2019RevisionsDateNo.

Revisions Date N

Project Information

VAIL HEALTH - DILLON
MEDICAL BUILDING
DILLON, COLORADO 80435


Sheet Information

Sheet Title:

LEVEL P1

Sheet Number:

A-01

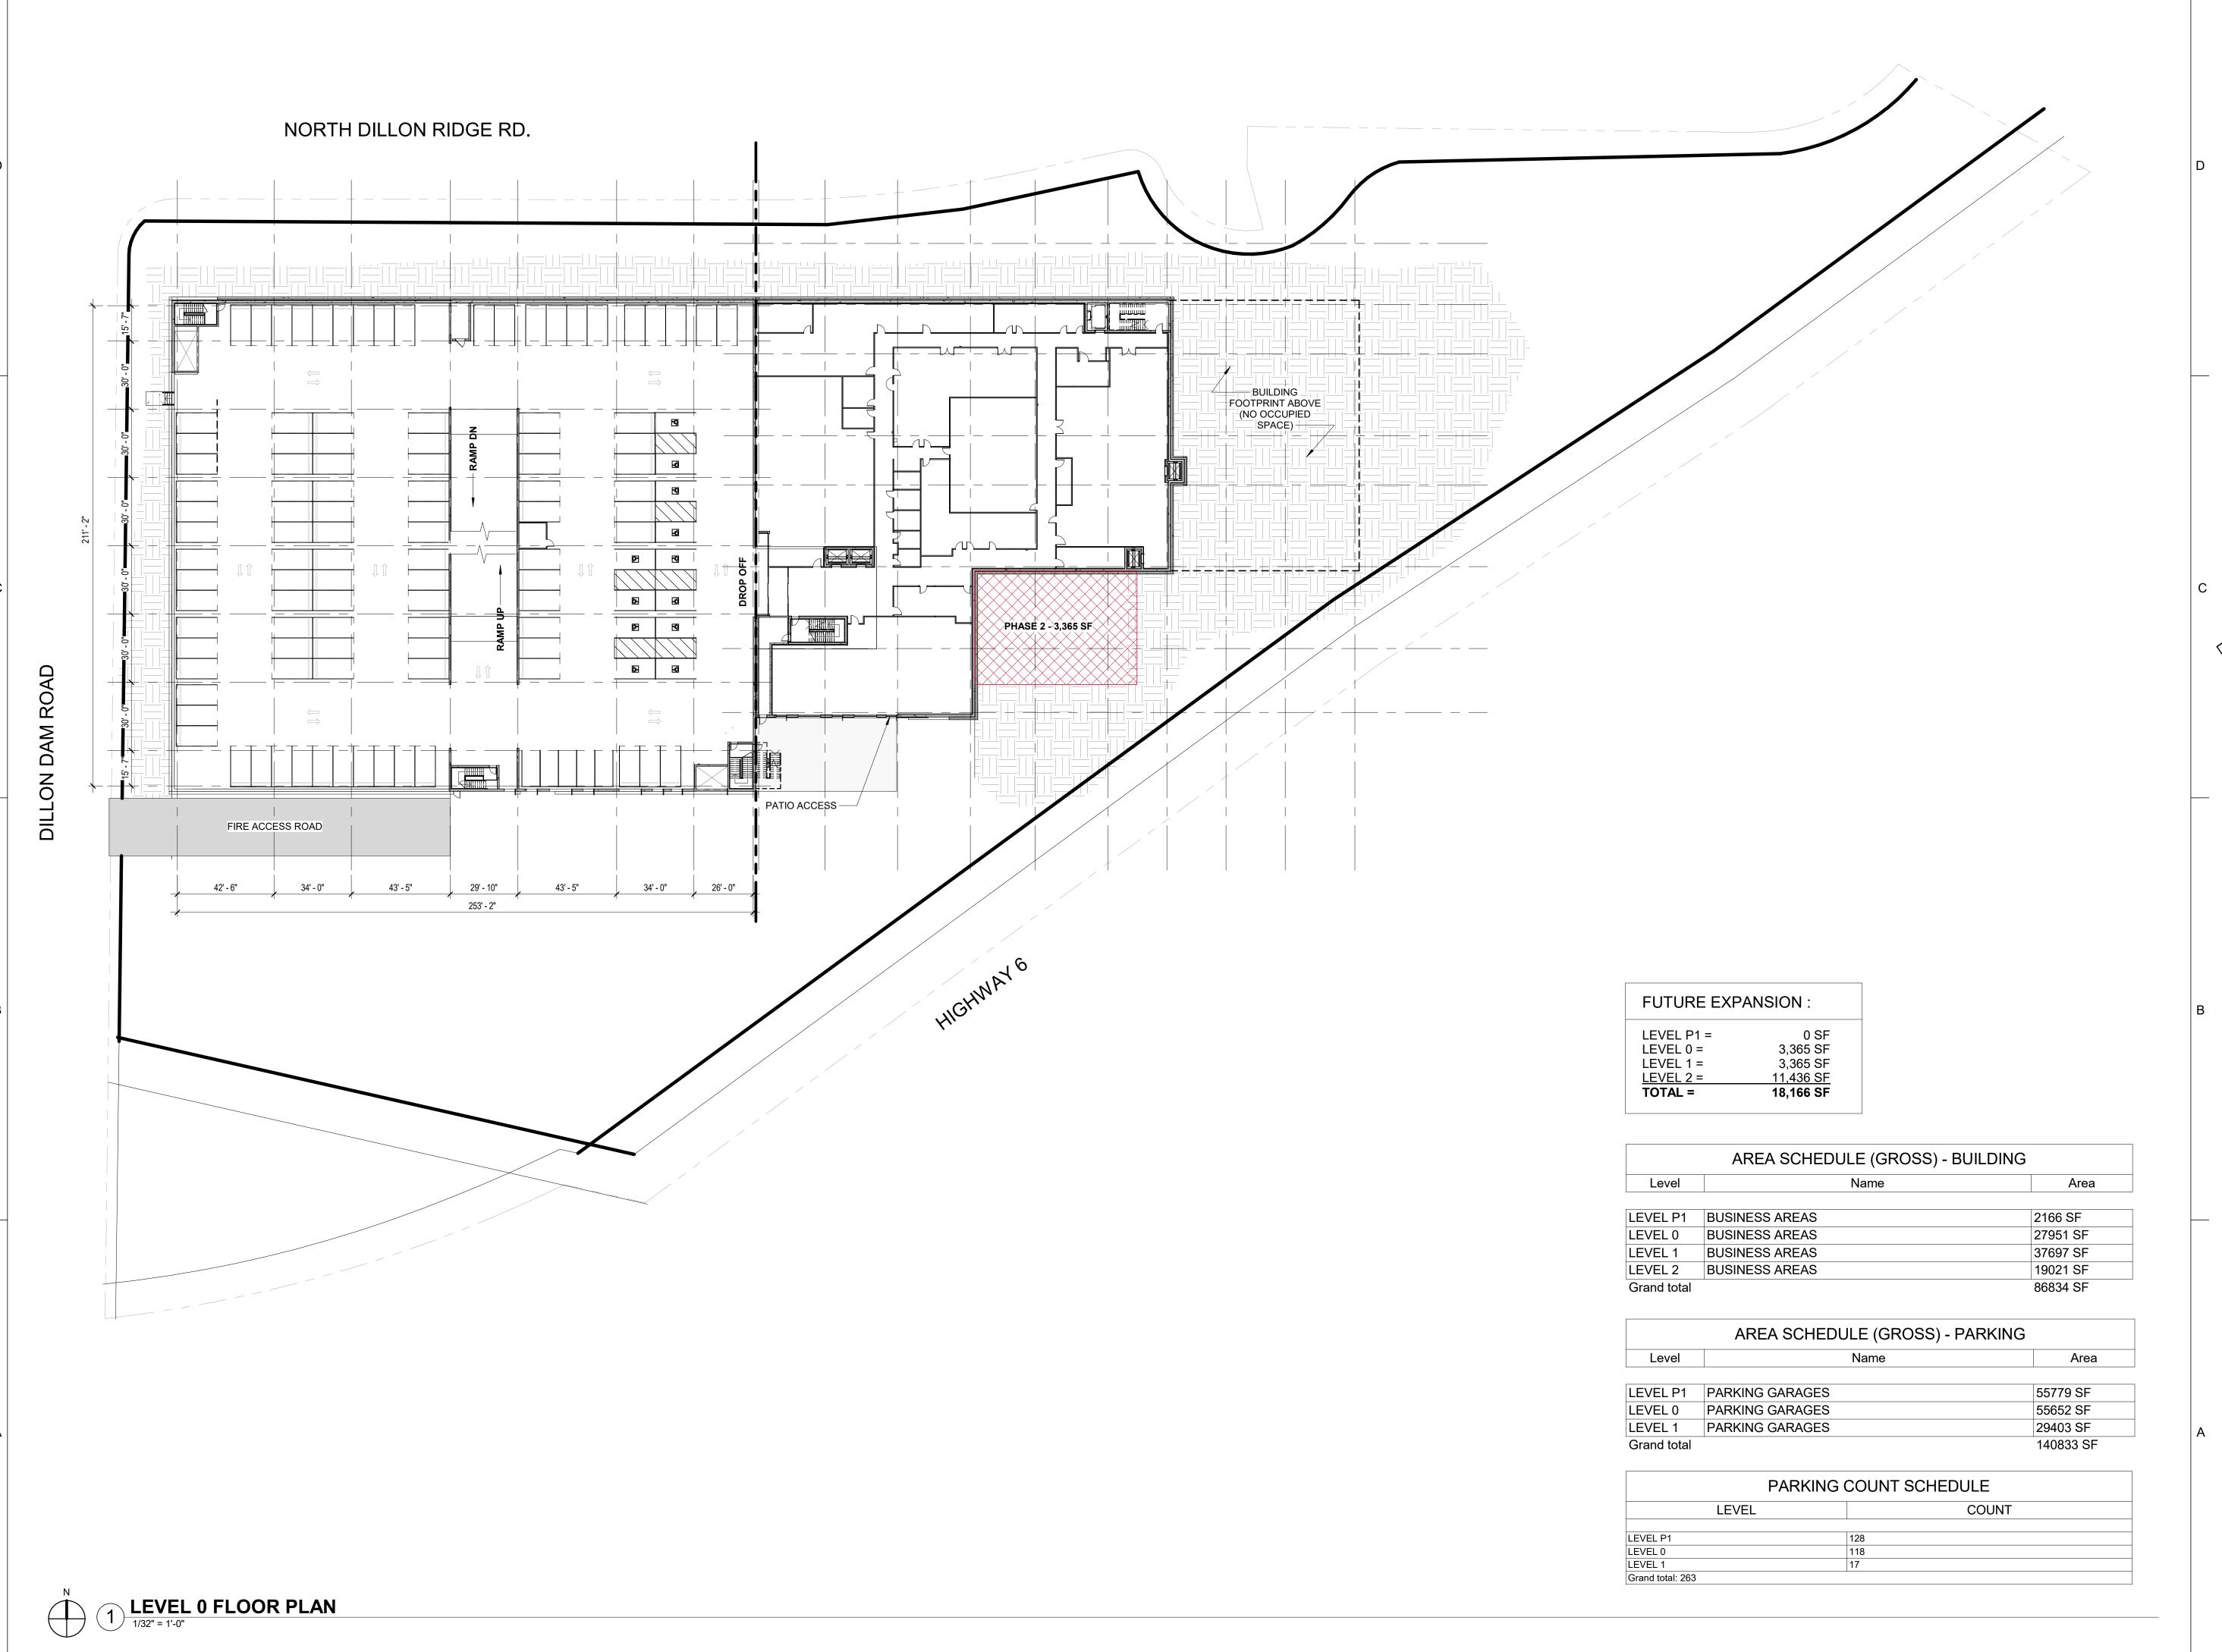





PUD DEVELOPMENT 07/23/2019
PLAN - REVISED

Revisions Date No.

Project Information

VAIL HEALTH - DILLON MEDICAL BUILDING DILLON, COLORADO 80435


Sheet Information

Sheet Title:

LEVEL 0

Sheet Number:

A-02

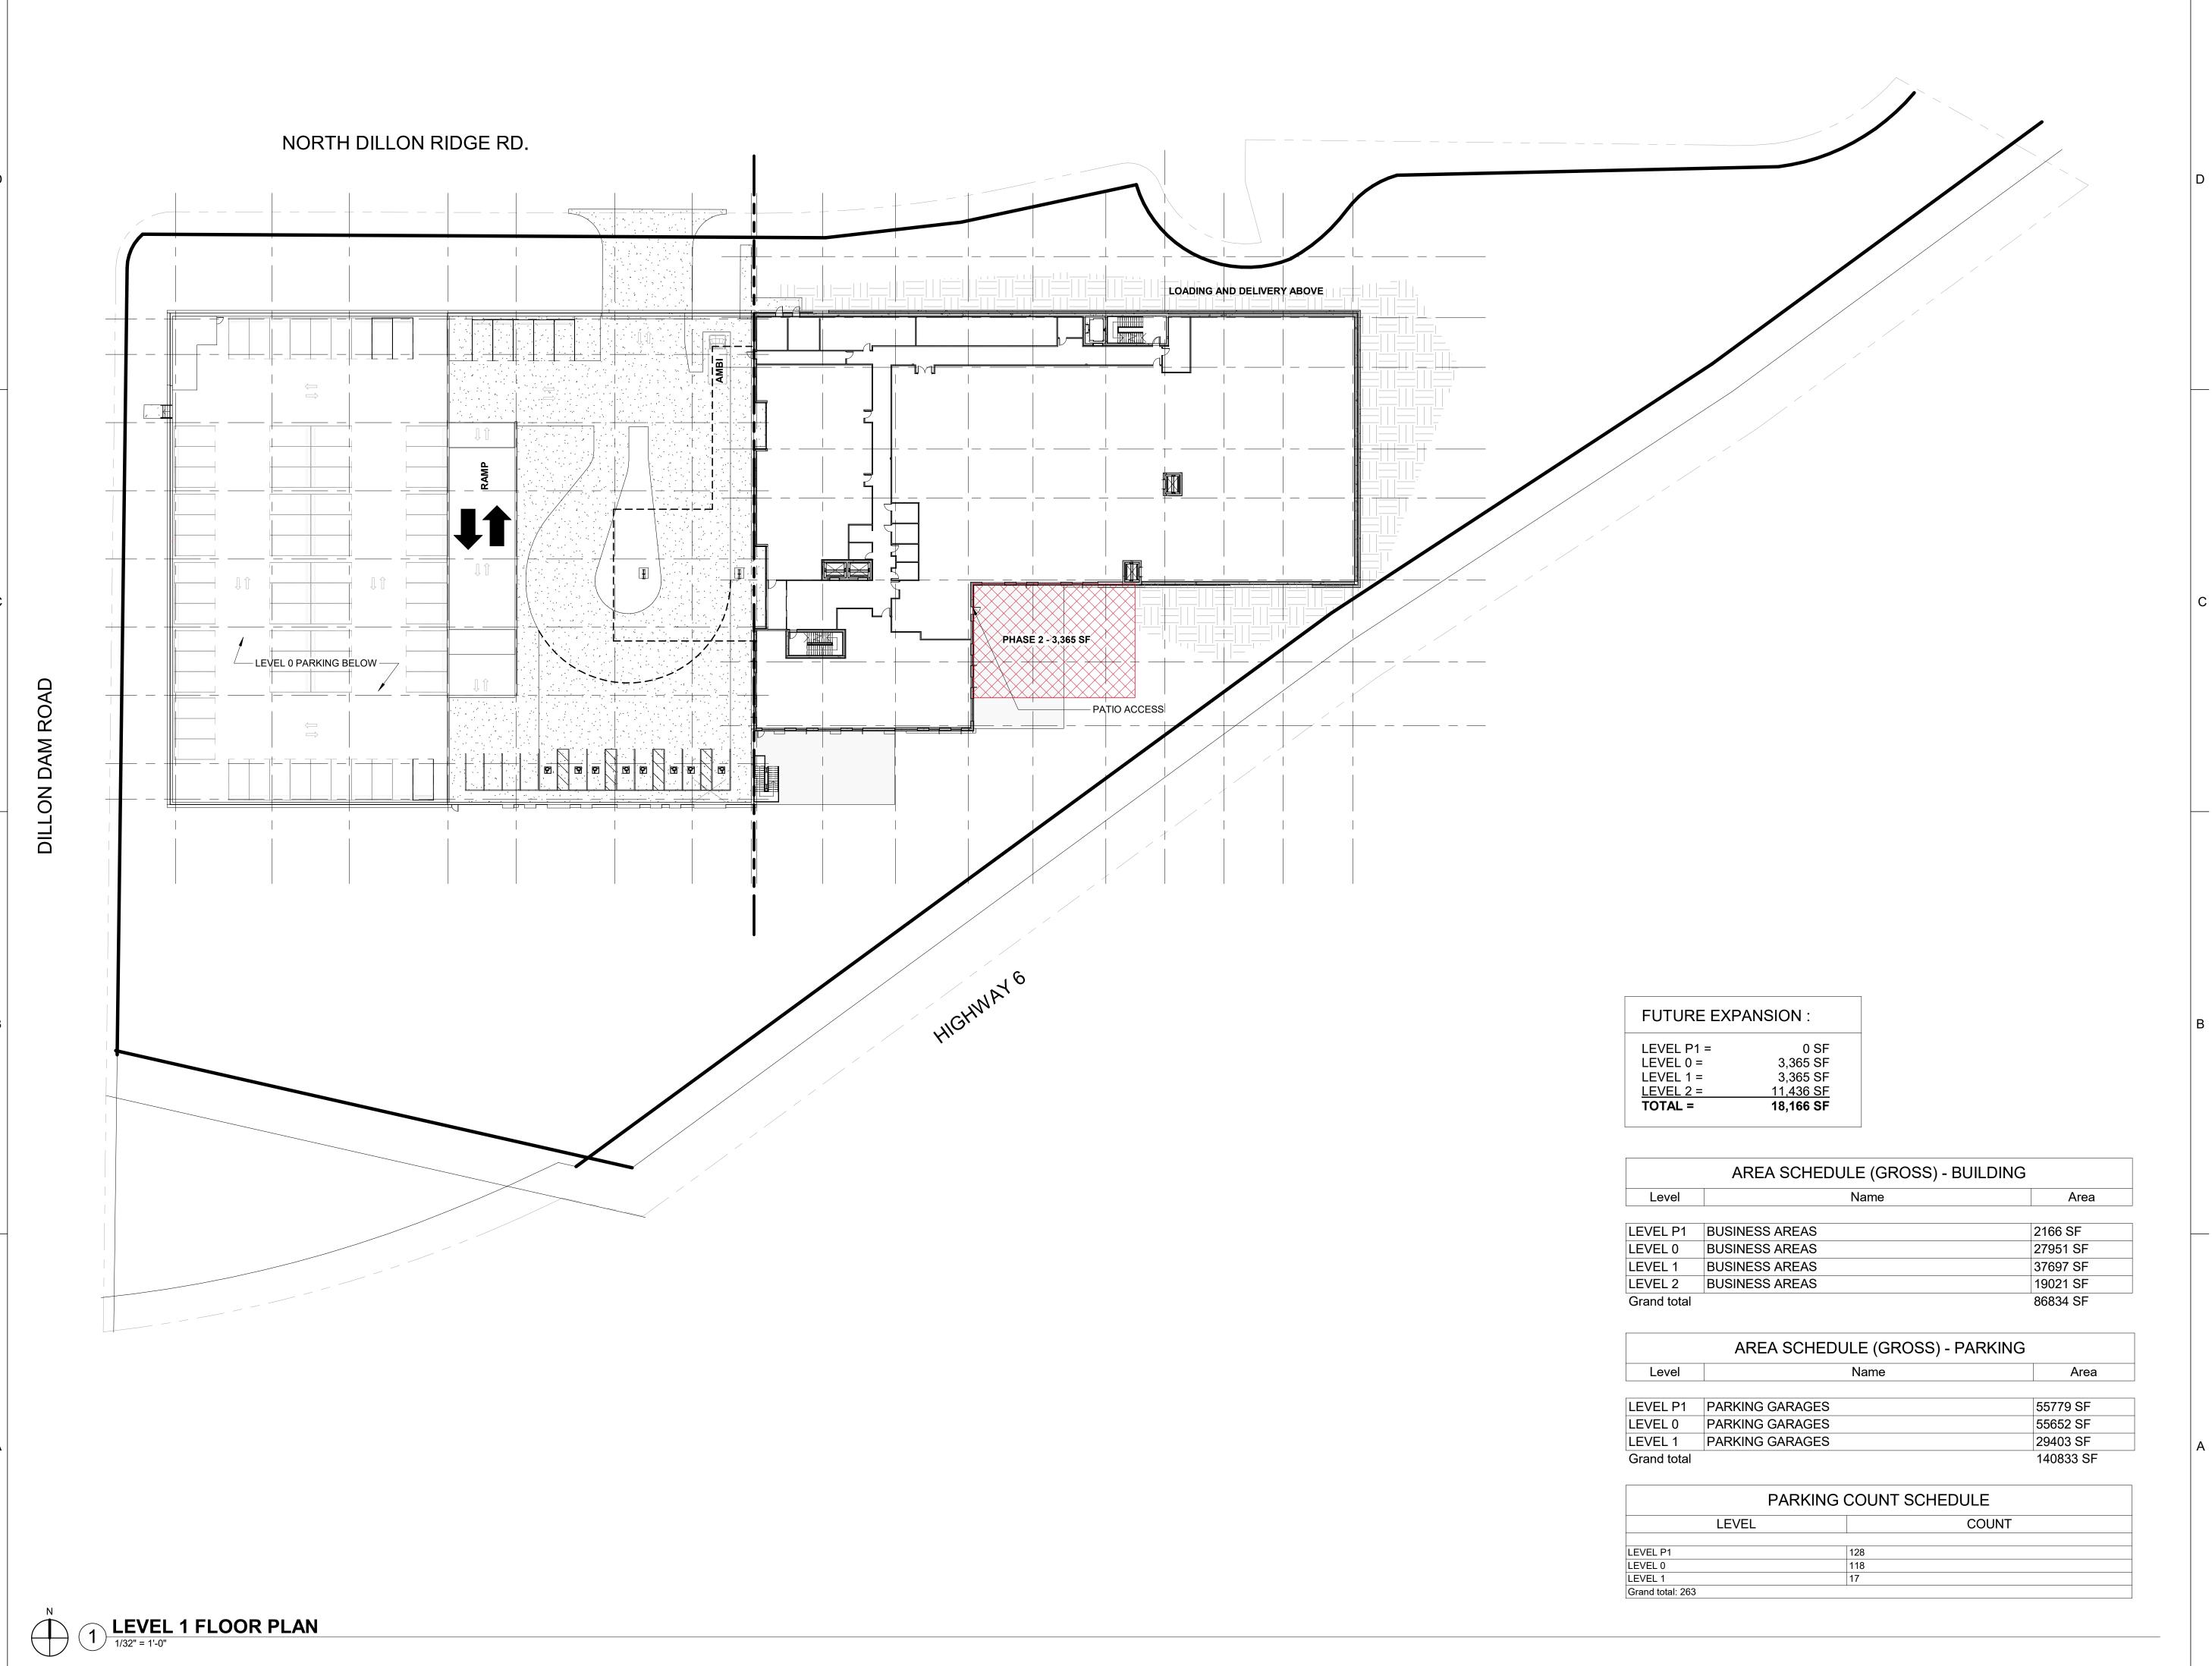





PUD DEVELOPMENT 07/23/201 PLAN - REVISED

Revisions Date No.

Project Information

VAIL HEALTH - DILLON MEDICAL BUILDING DILLON, COLORADO 80435


Sheet Information

Sheet Title:


LEVEL 1

Sheet Number:

A-03

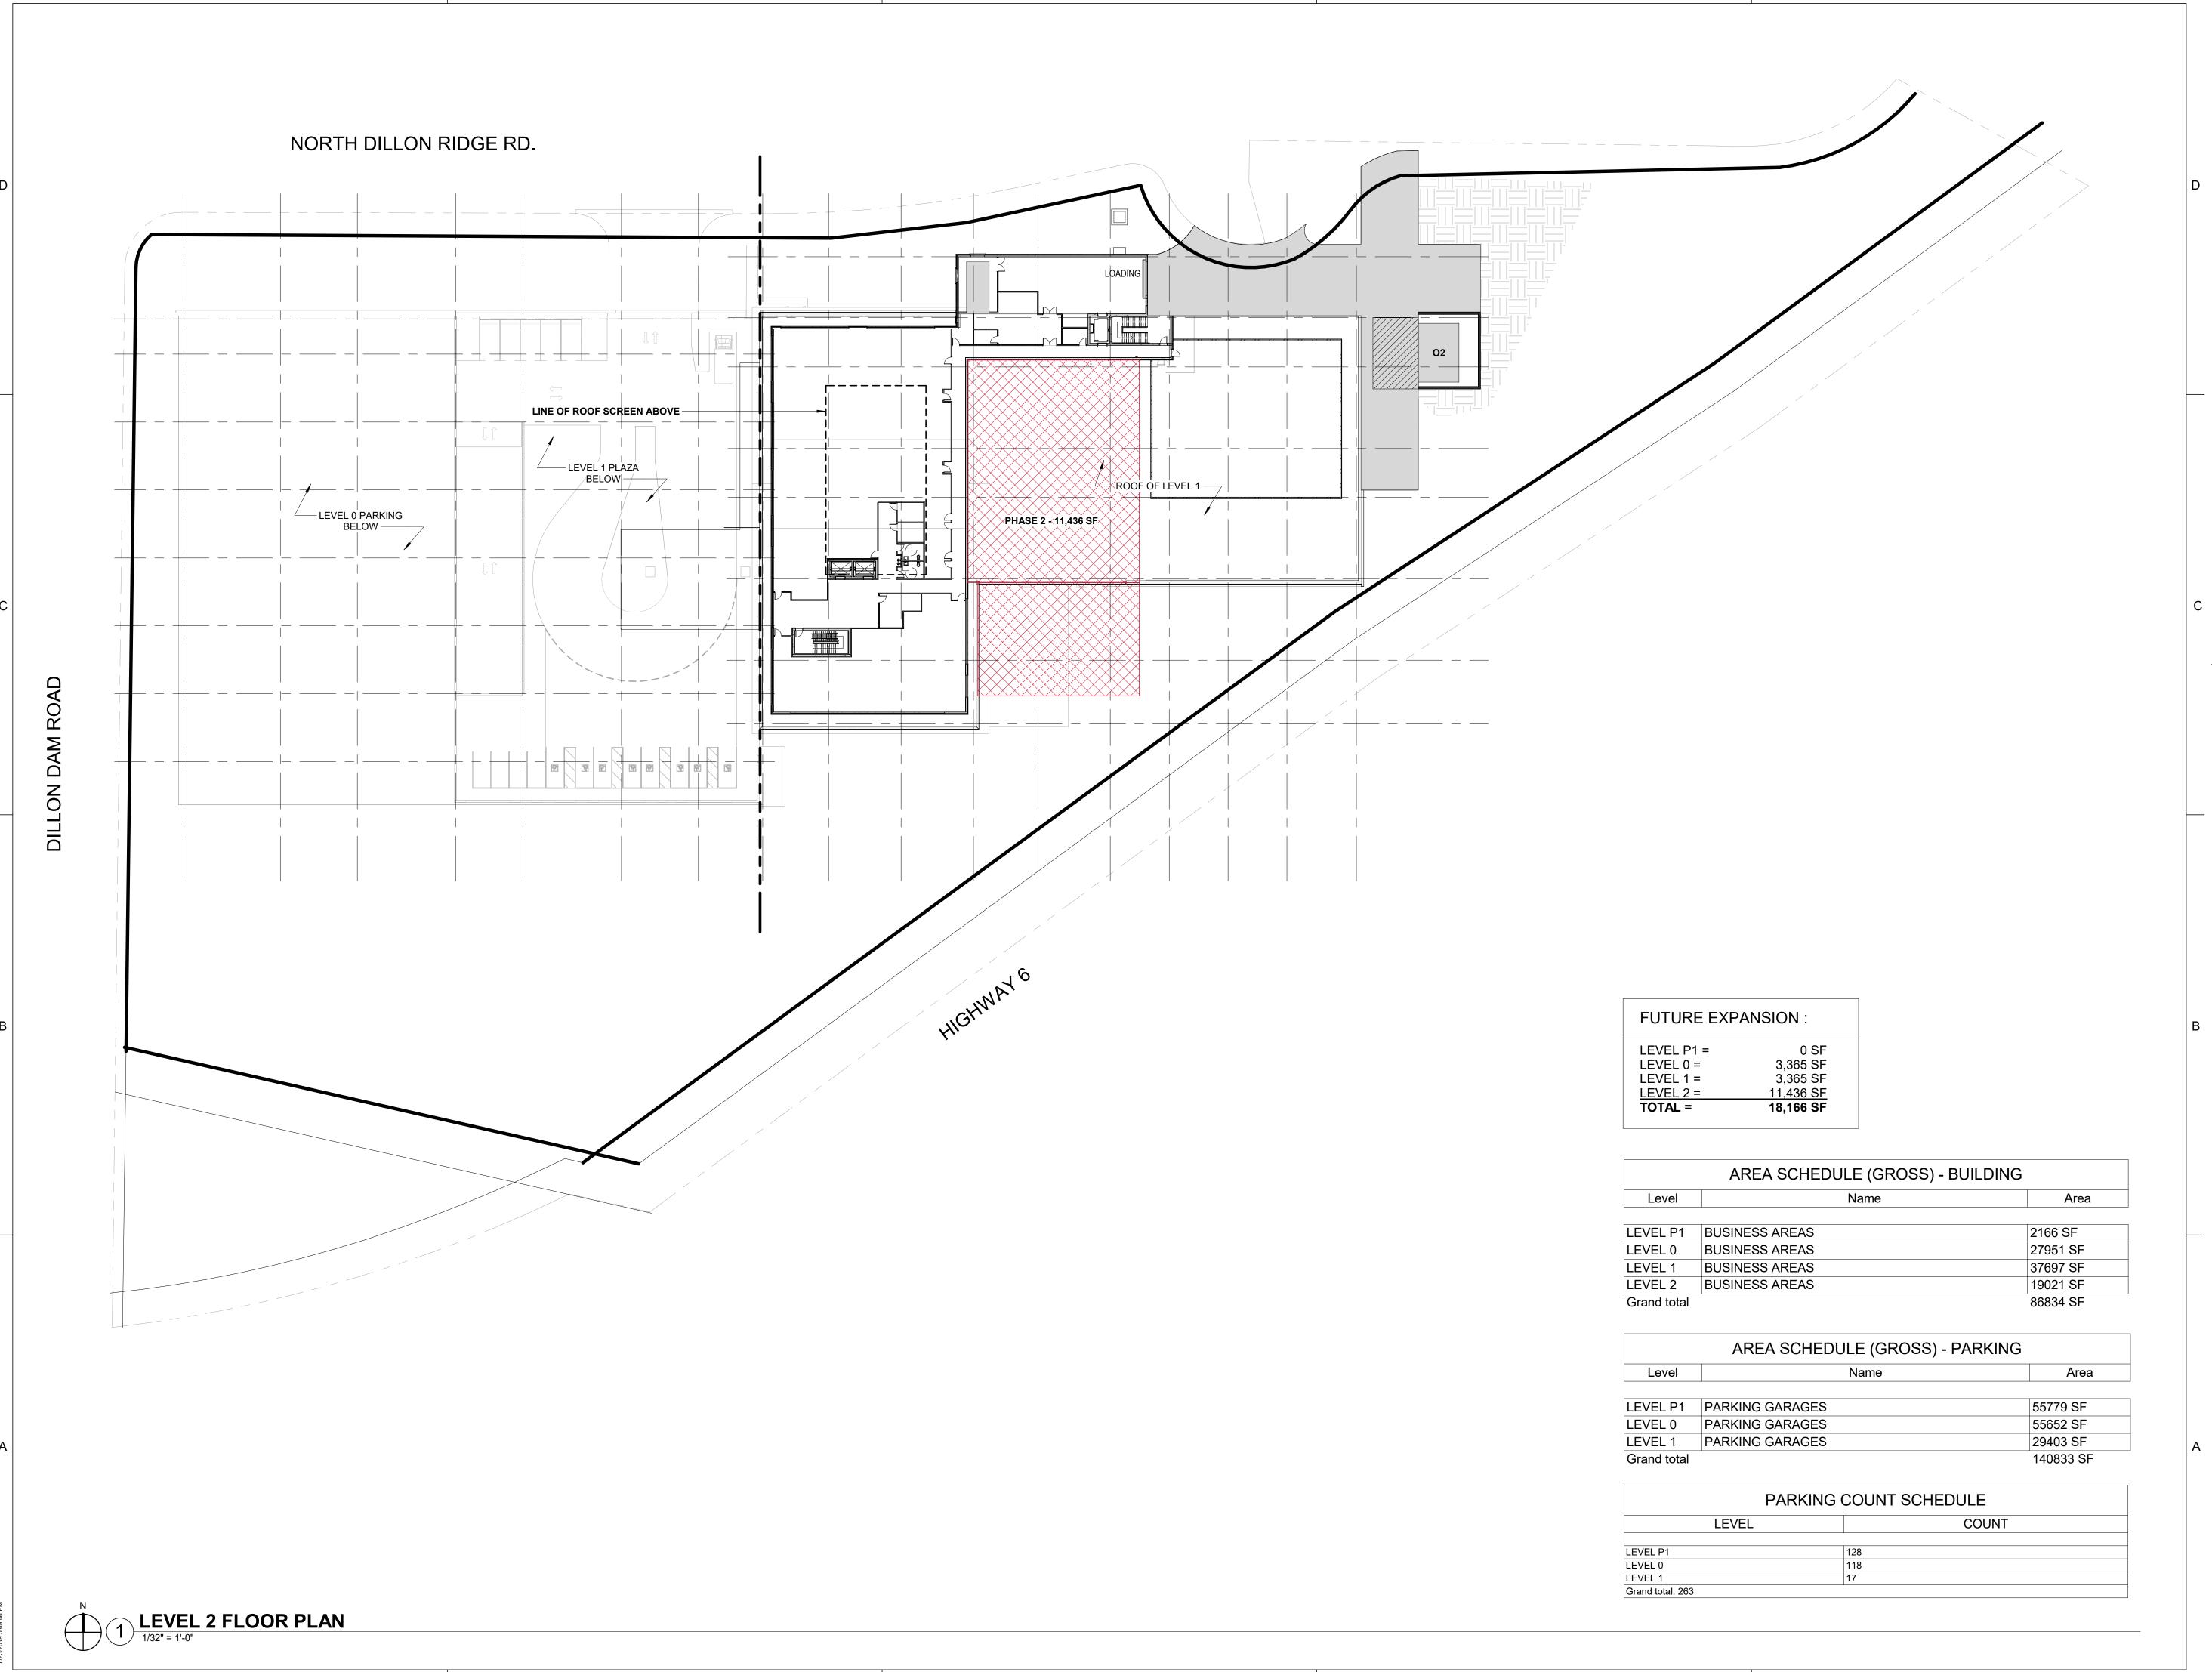



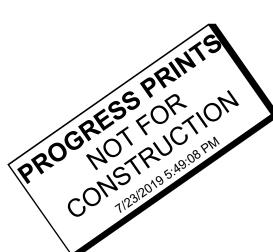

Original Issuance PUD DEVELOPMENT PLAN - REVISED Revisions Date No.

Project Information


VAIL HEALTH - DILLON MEDICAL BUILDING DILLON, COLORADO 80435

Sheet Information

Sheet Title:

LEVEL 2

Sheet Number:

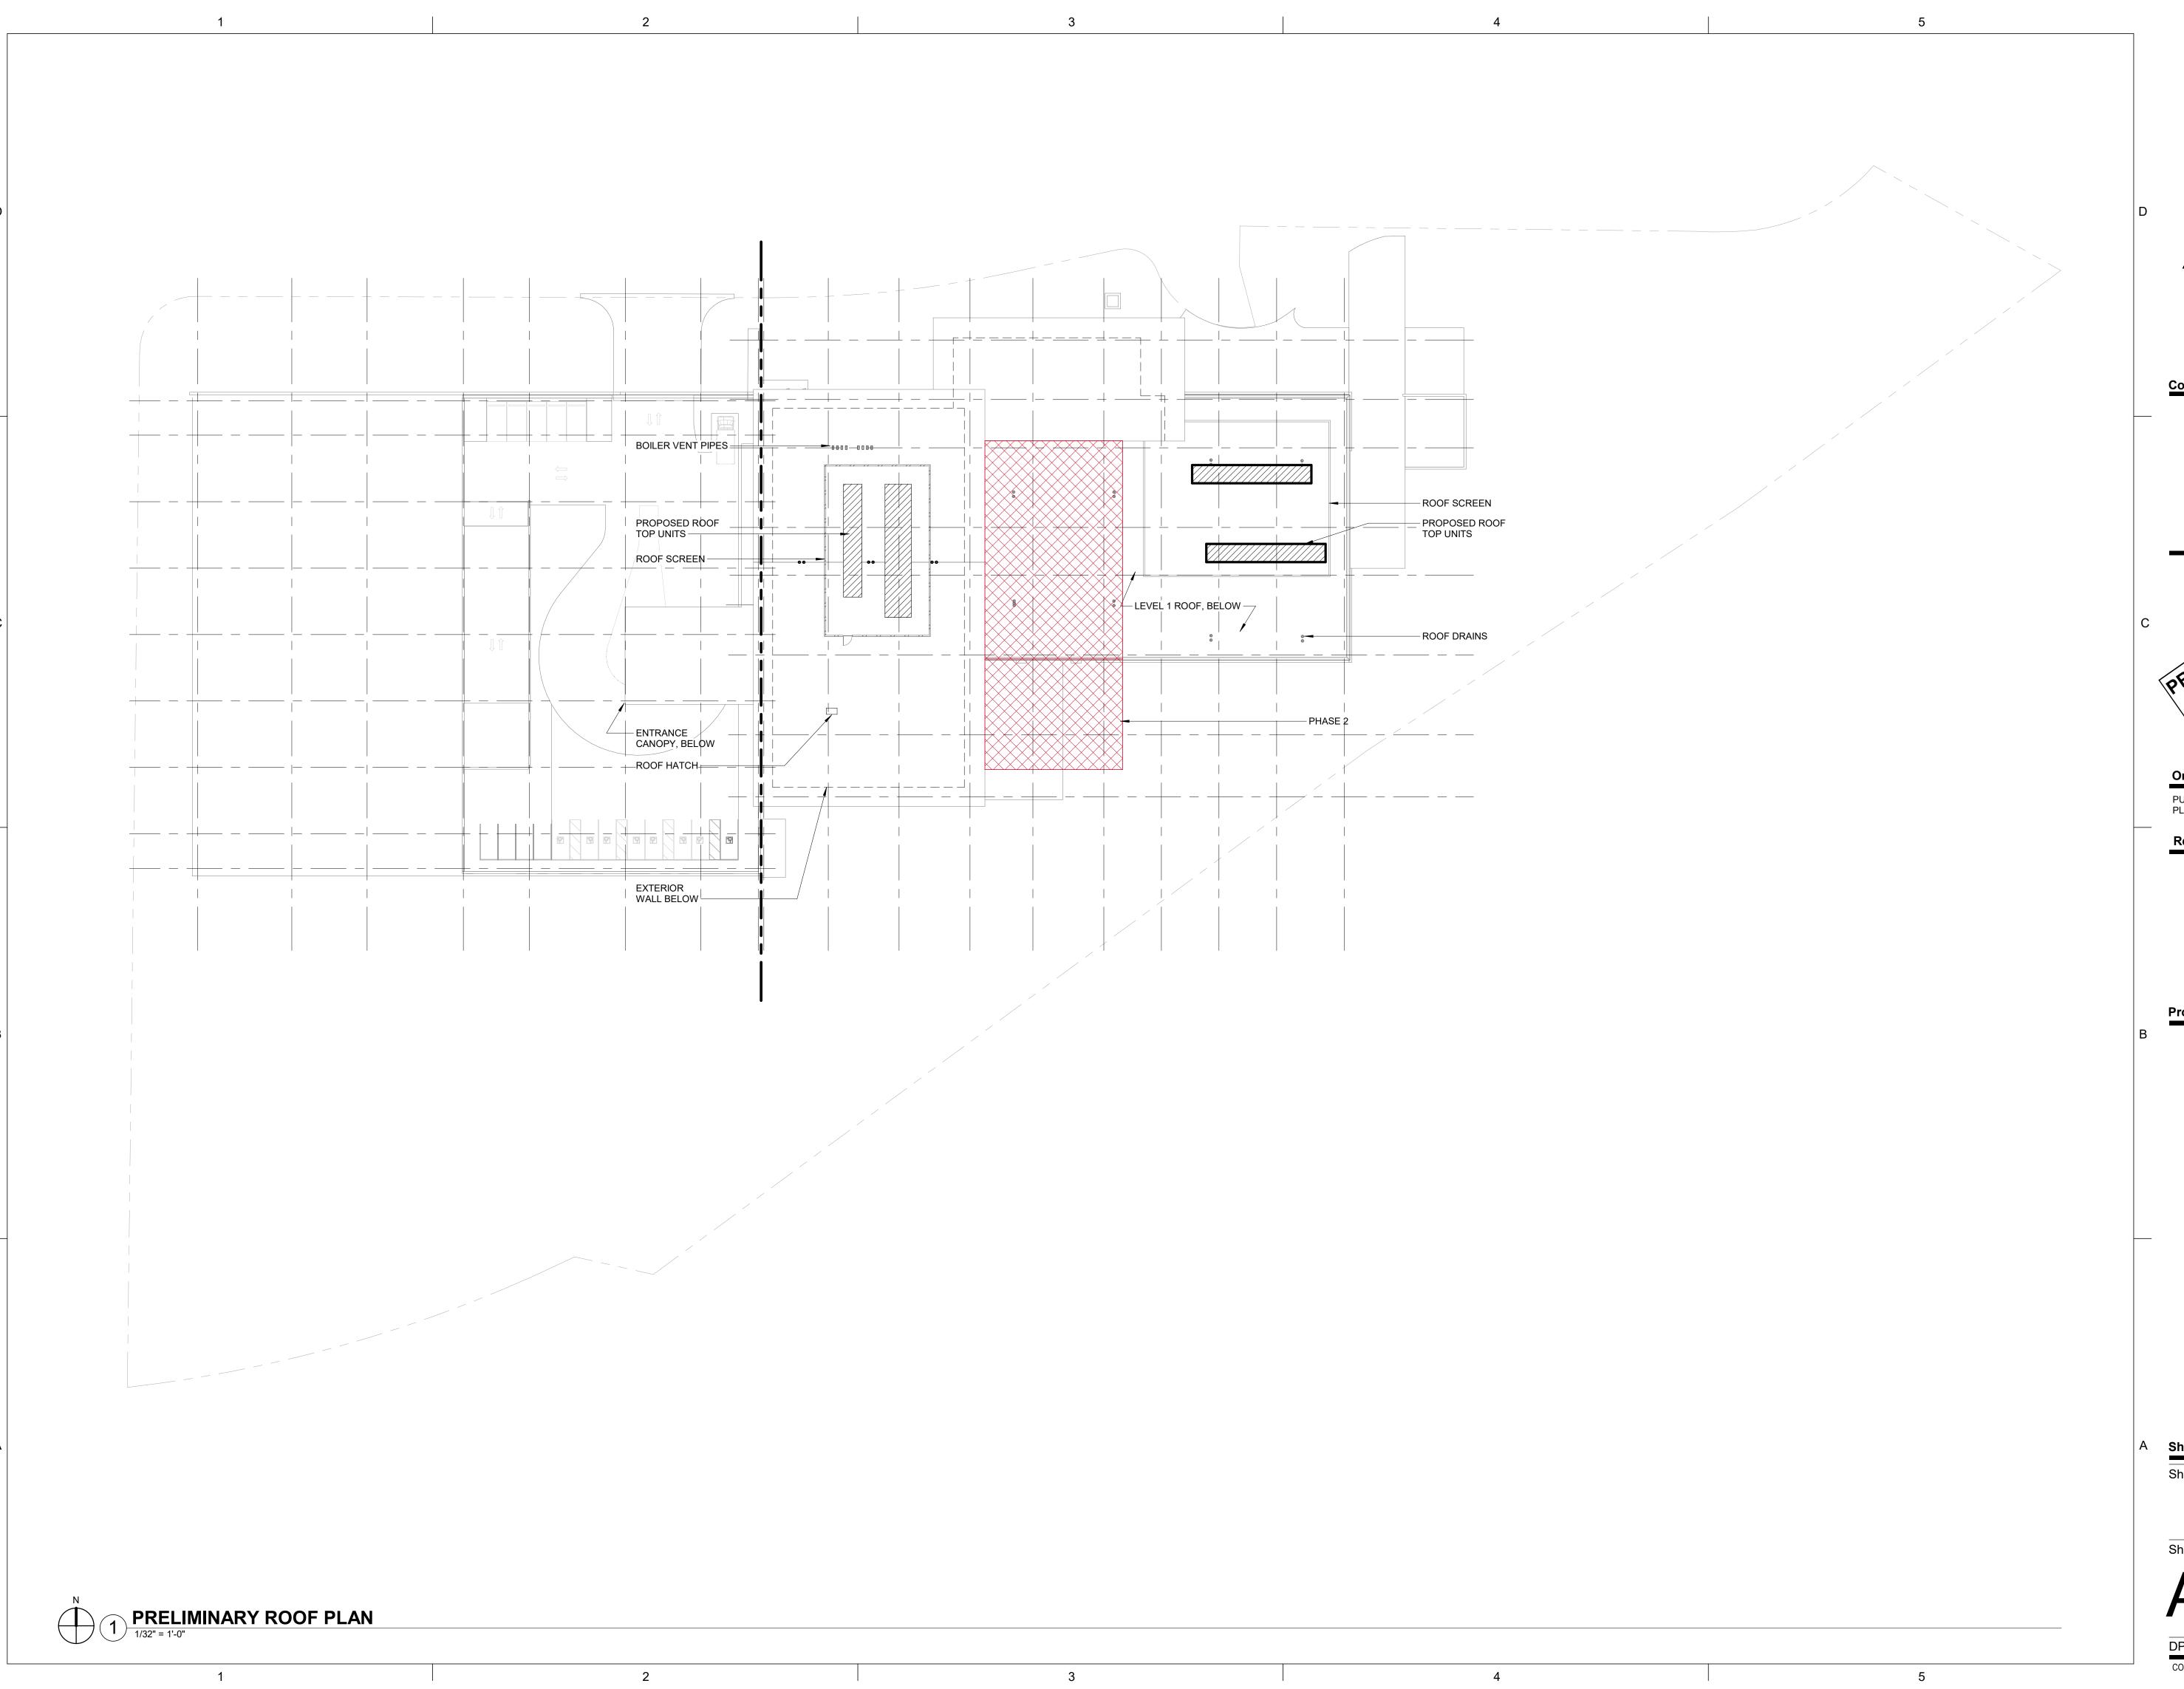





Original IssuanceDatePUD DEVELOPMENT
PLAN - REVISED07/23/2019

Revisions Date No.

Project Information


VAIL HEALTH - DILLON MEDICAL BUILDING DILLON, COLORADO 80435

Sheet Information


Sheet Title:
ROOF PLAN

Sheet Number:

A-04.1

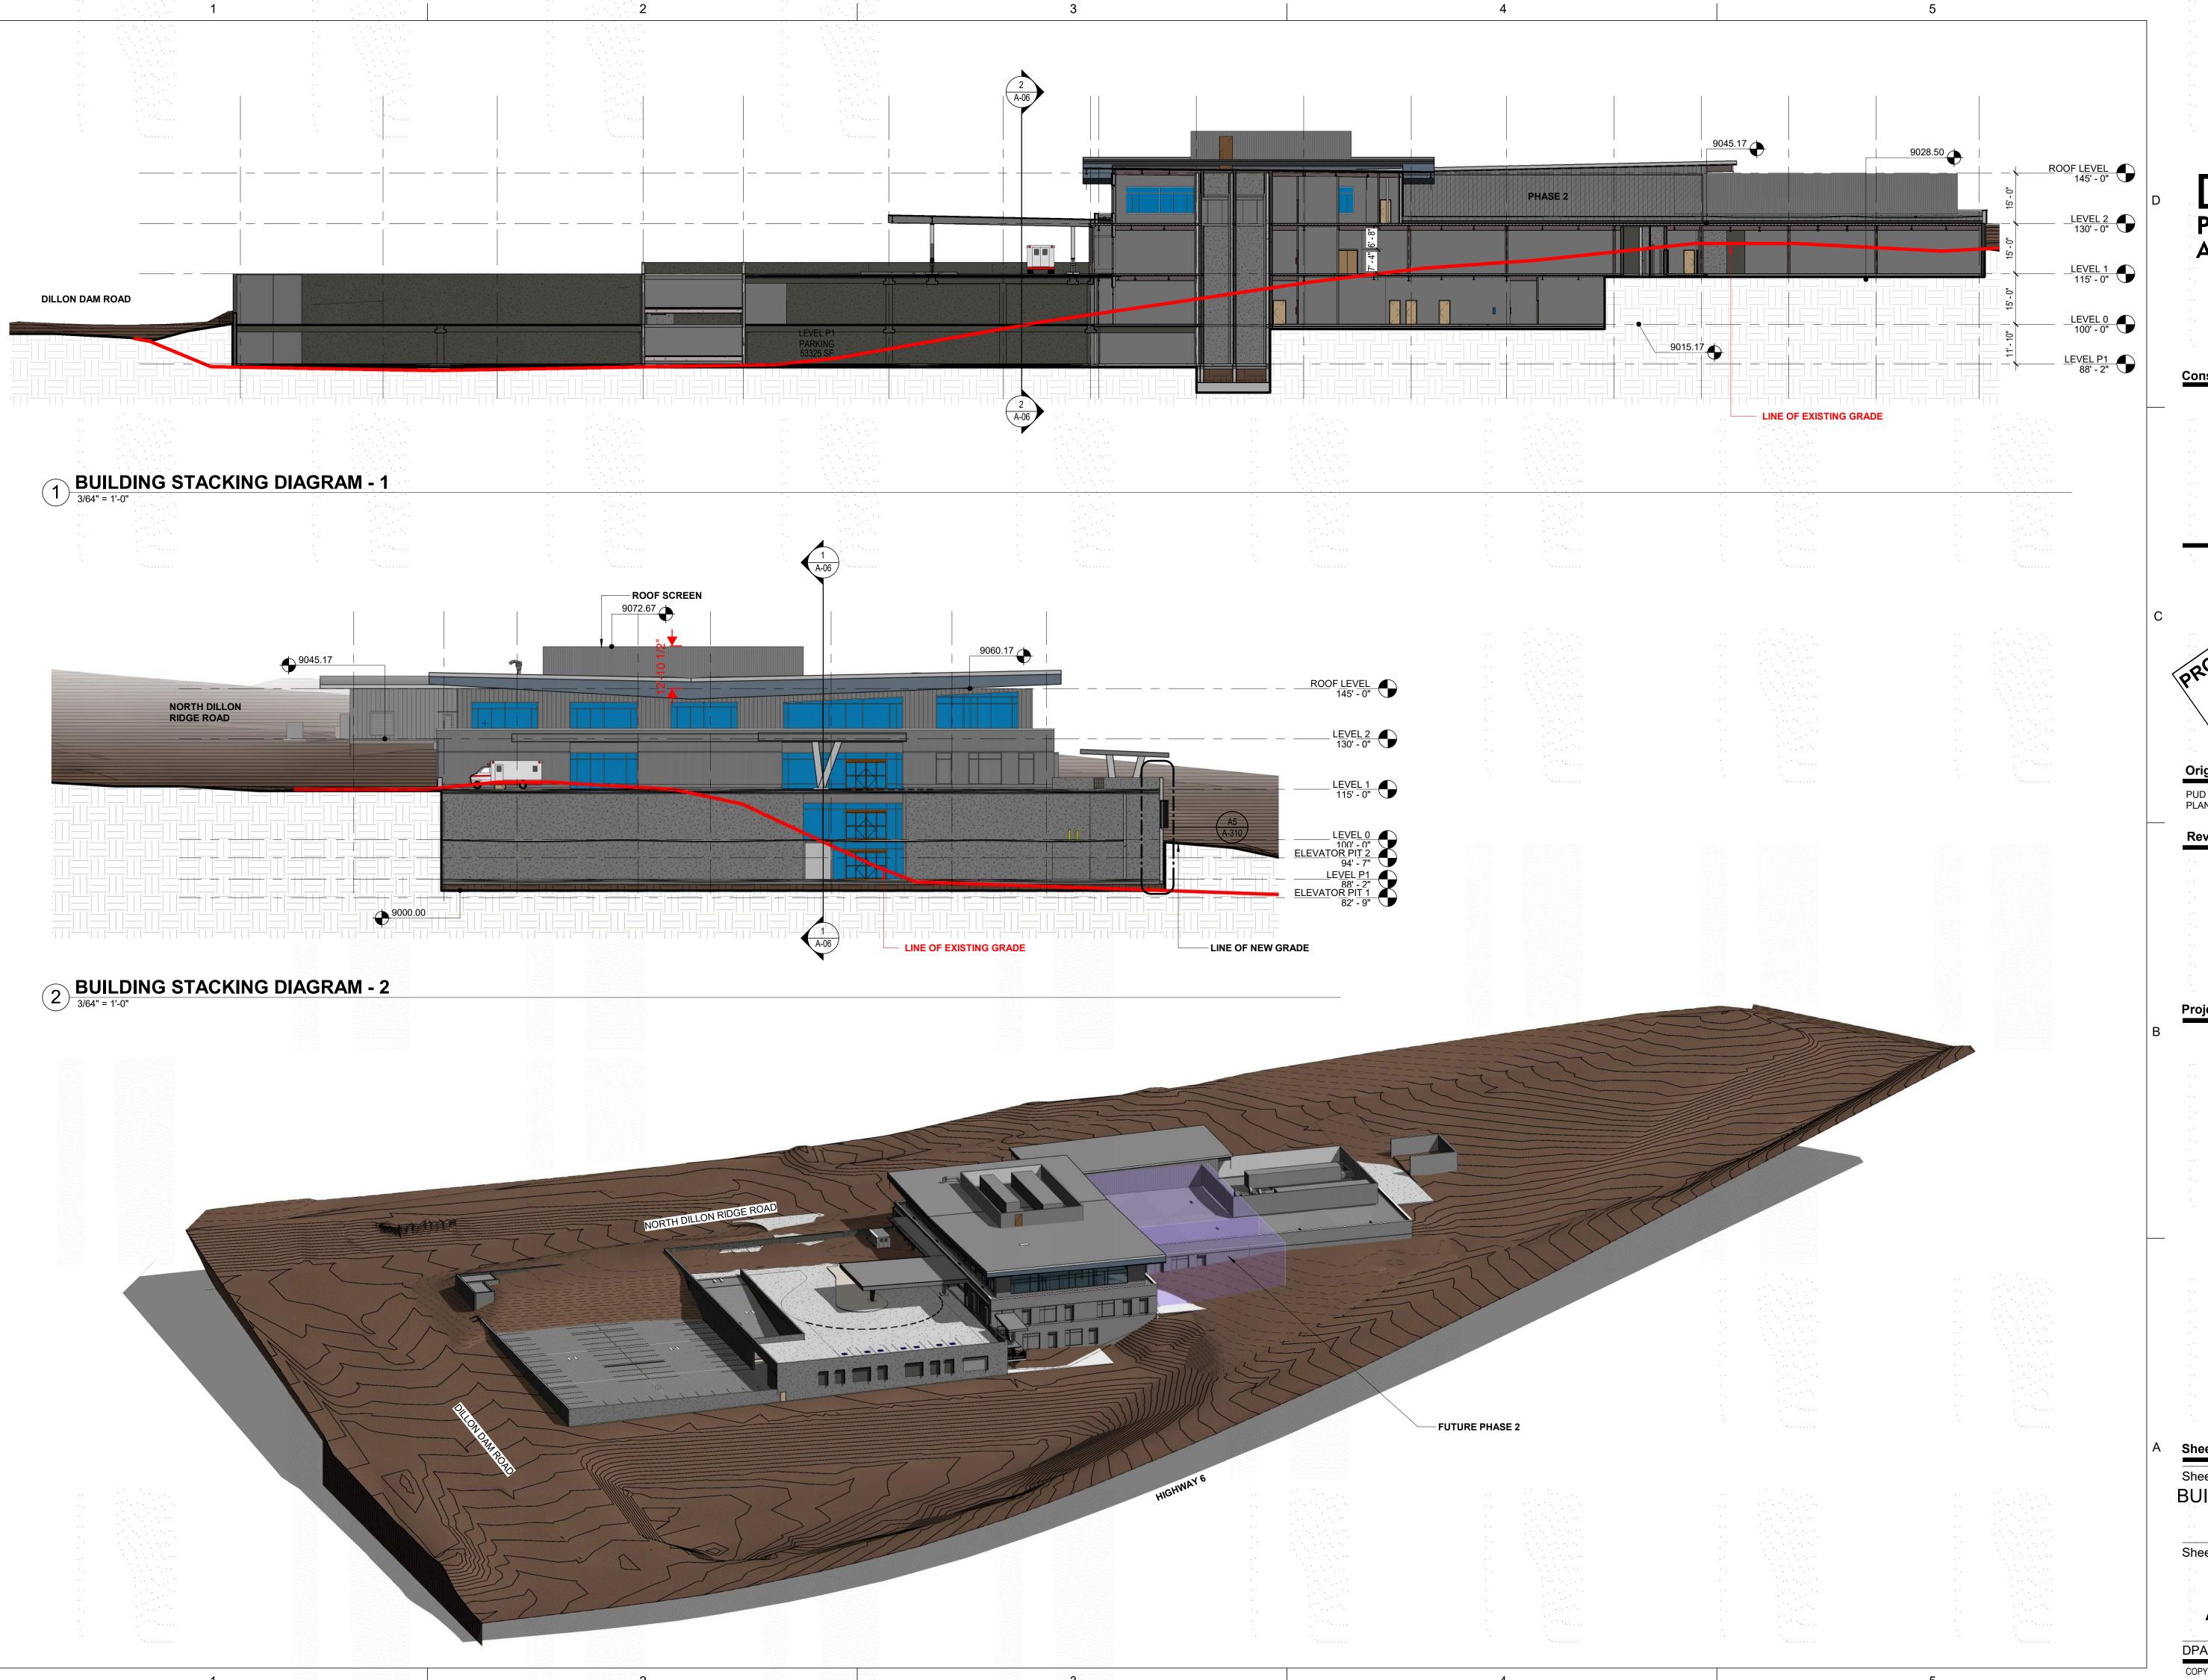



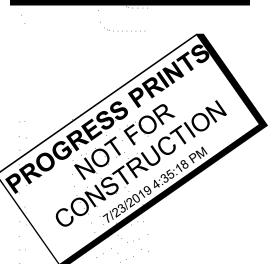

Original Issuance PUD DEVELOPMENT PLAN - REVISED 07/23/2019

Date No. Revisions

Project Information

VAIL HEALTH - DILLON MEDICAL BUILDING

Sheet Information

BUILDING STACKING DIAGRAMS

Sheet Number:






WEST ELEVATION



NORTH ELEVATION



SOUTH ELEVATION

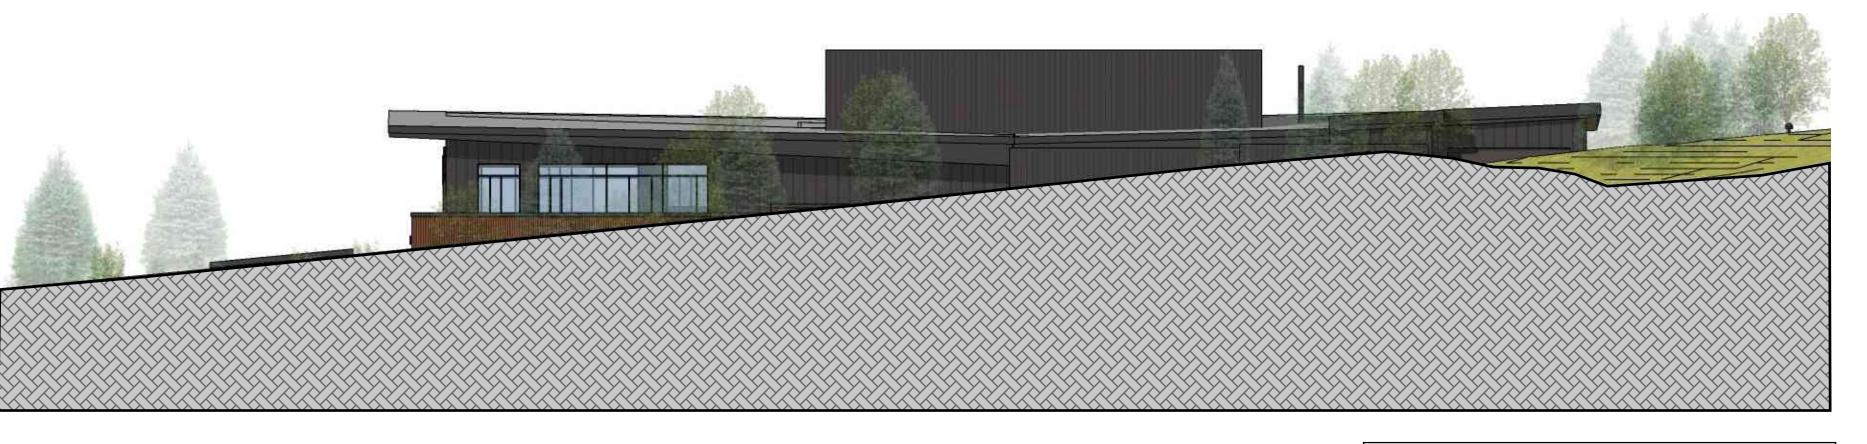

EAST ELEVATION

PARTNERSHIP ARCHITECTS DENVER OFFICE 2901 Blake Street, Suite 100 Denver, CO 80205 303.861.8555

Consultant

Original Issuance PUD DEVELOPMENT PLAN - REVISED

Revisions

Project Information

VAIL HEALTH - DILLON MEDICAL BUILDING DILLON, COLORADO 80435

Sheet Information

Sheet Title: SITE SECTIONS/ELEVATIONS

Sheet Number:



SOUTH PERSPECTIVE - PHASE 1



SOUTH PERSPECTIVE - PHASE 2



Consultant



PUD DEVELOPMENT 07/23/2011 PLAN - REVISED

Revisions Da

Project Information

VAIL HEALTH - DILLON MEDICAL BUILDING DILLON, COLORADO 80435

Sheet Information


Sheet Title:
PROJECT
RENDERINGS

Sheet Number:

A-08



NORTH PERSPECTIVE - PHASE 1

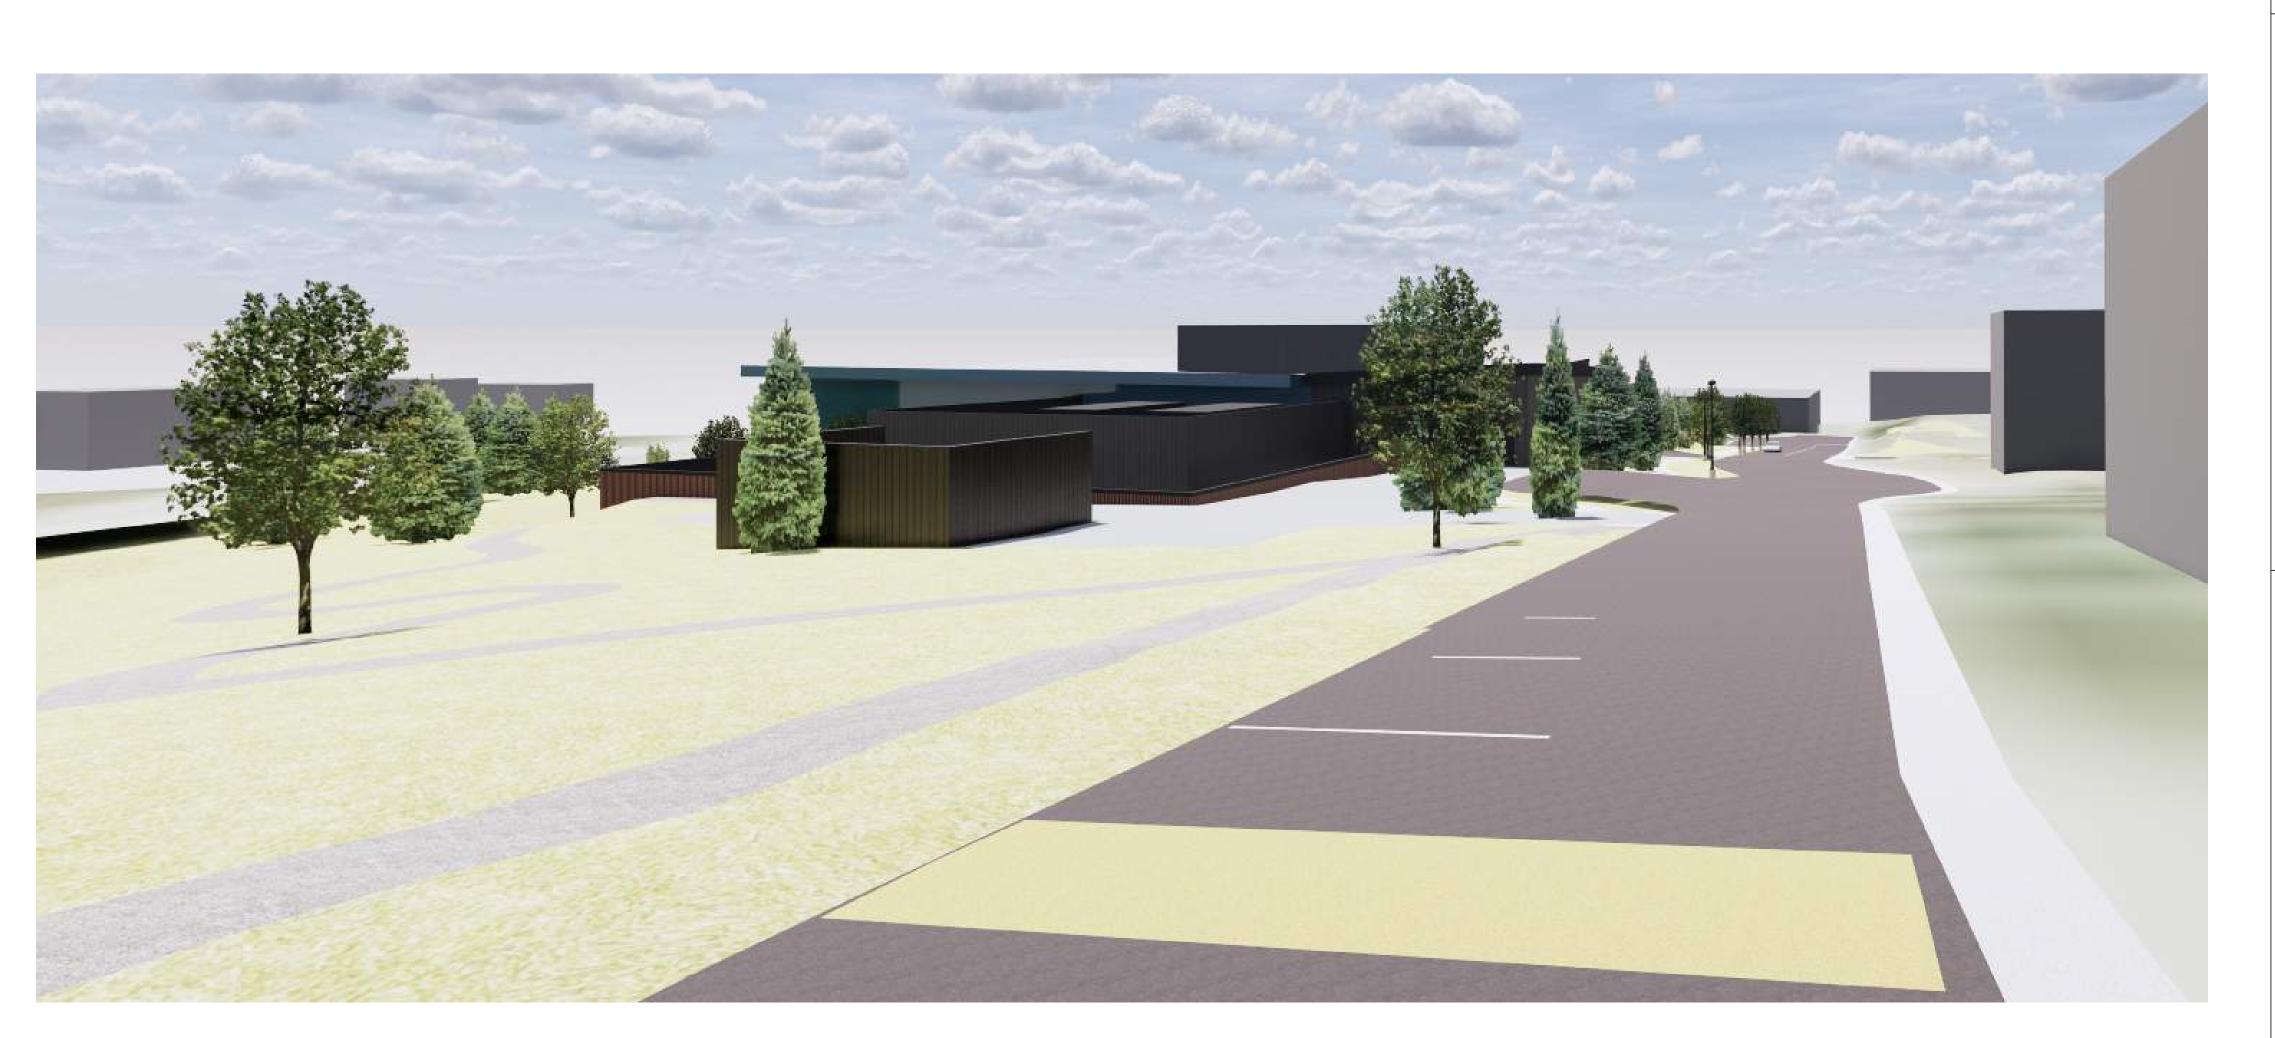

NORTH PERSPECTIVE - PHASE 2

DAVIS
PARTNERSHIP
ARCHITECTS DENVER OFFICE 2901 Blake Street, Suite 100 Denver, CO 80205 303.861.8555

Consultant

Original Issuance PUD DEVELOPMENT 07/23/2019 PLAN - REVISED

Revisions

Project Information

VAIL HEALTH - DILLON MEDICAL BUILDING DILLON, COLORADO 80435

Sheet Information

Sheet Title:
PROJECT
RENDERINGS

Sheet Number:







BUILDING ENTRY PERSPECTIVE

DAVIS
PARTNERSHIP
ARCHITECTS DENVER OFFICE 2901 Blake Street, Suite 100 Denver, CO 80205 303.861.8555

Consultant



Original Issuance PUD DEVELOPMENT 07/23/2019 PLAN - REVISED

Revisions


Project Information

VAIL HEALTH - DILLON MEDICAL BUILDING DILLON, COLORADO 80435

Sheet Information

Sheet Title:
PROJECT
RENDERINGS

Sheet Number:

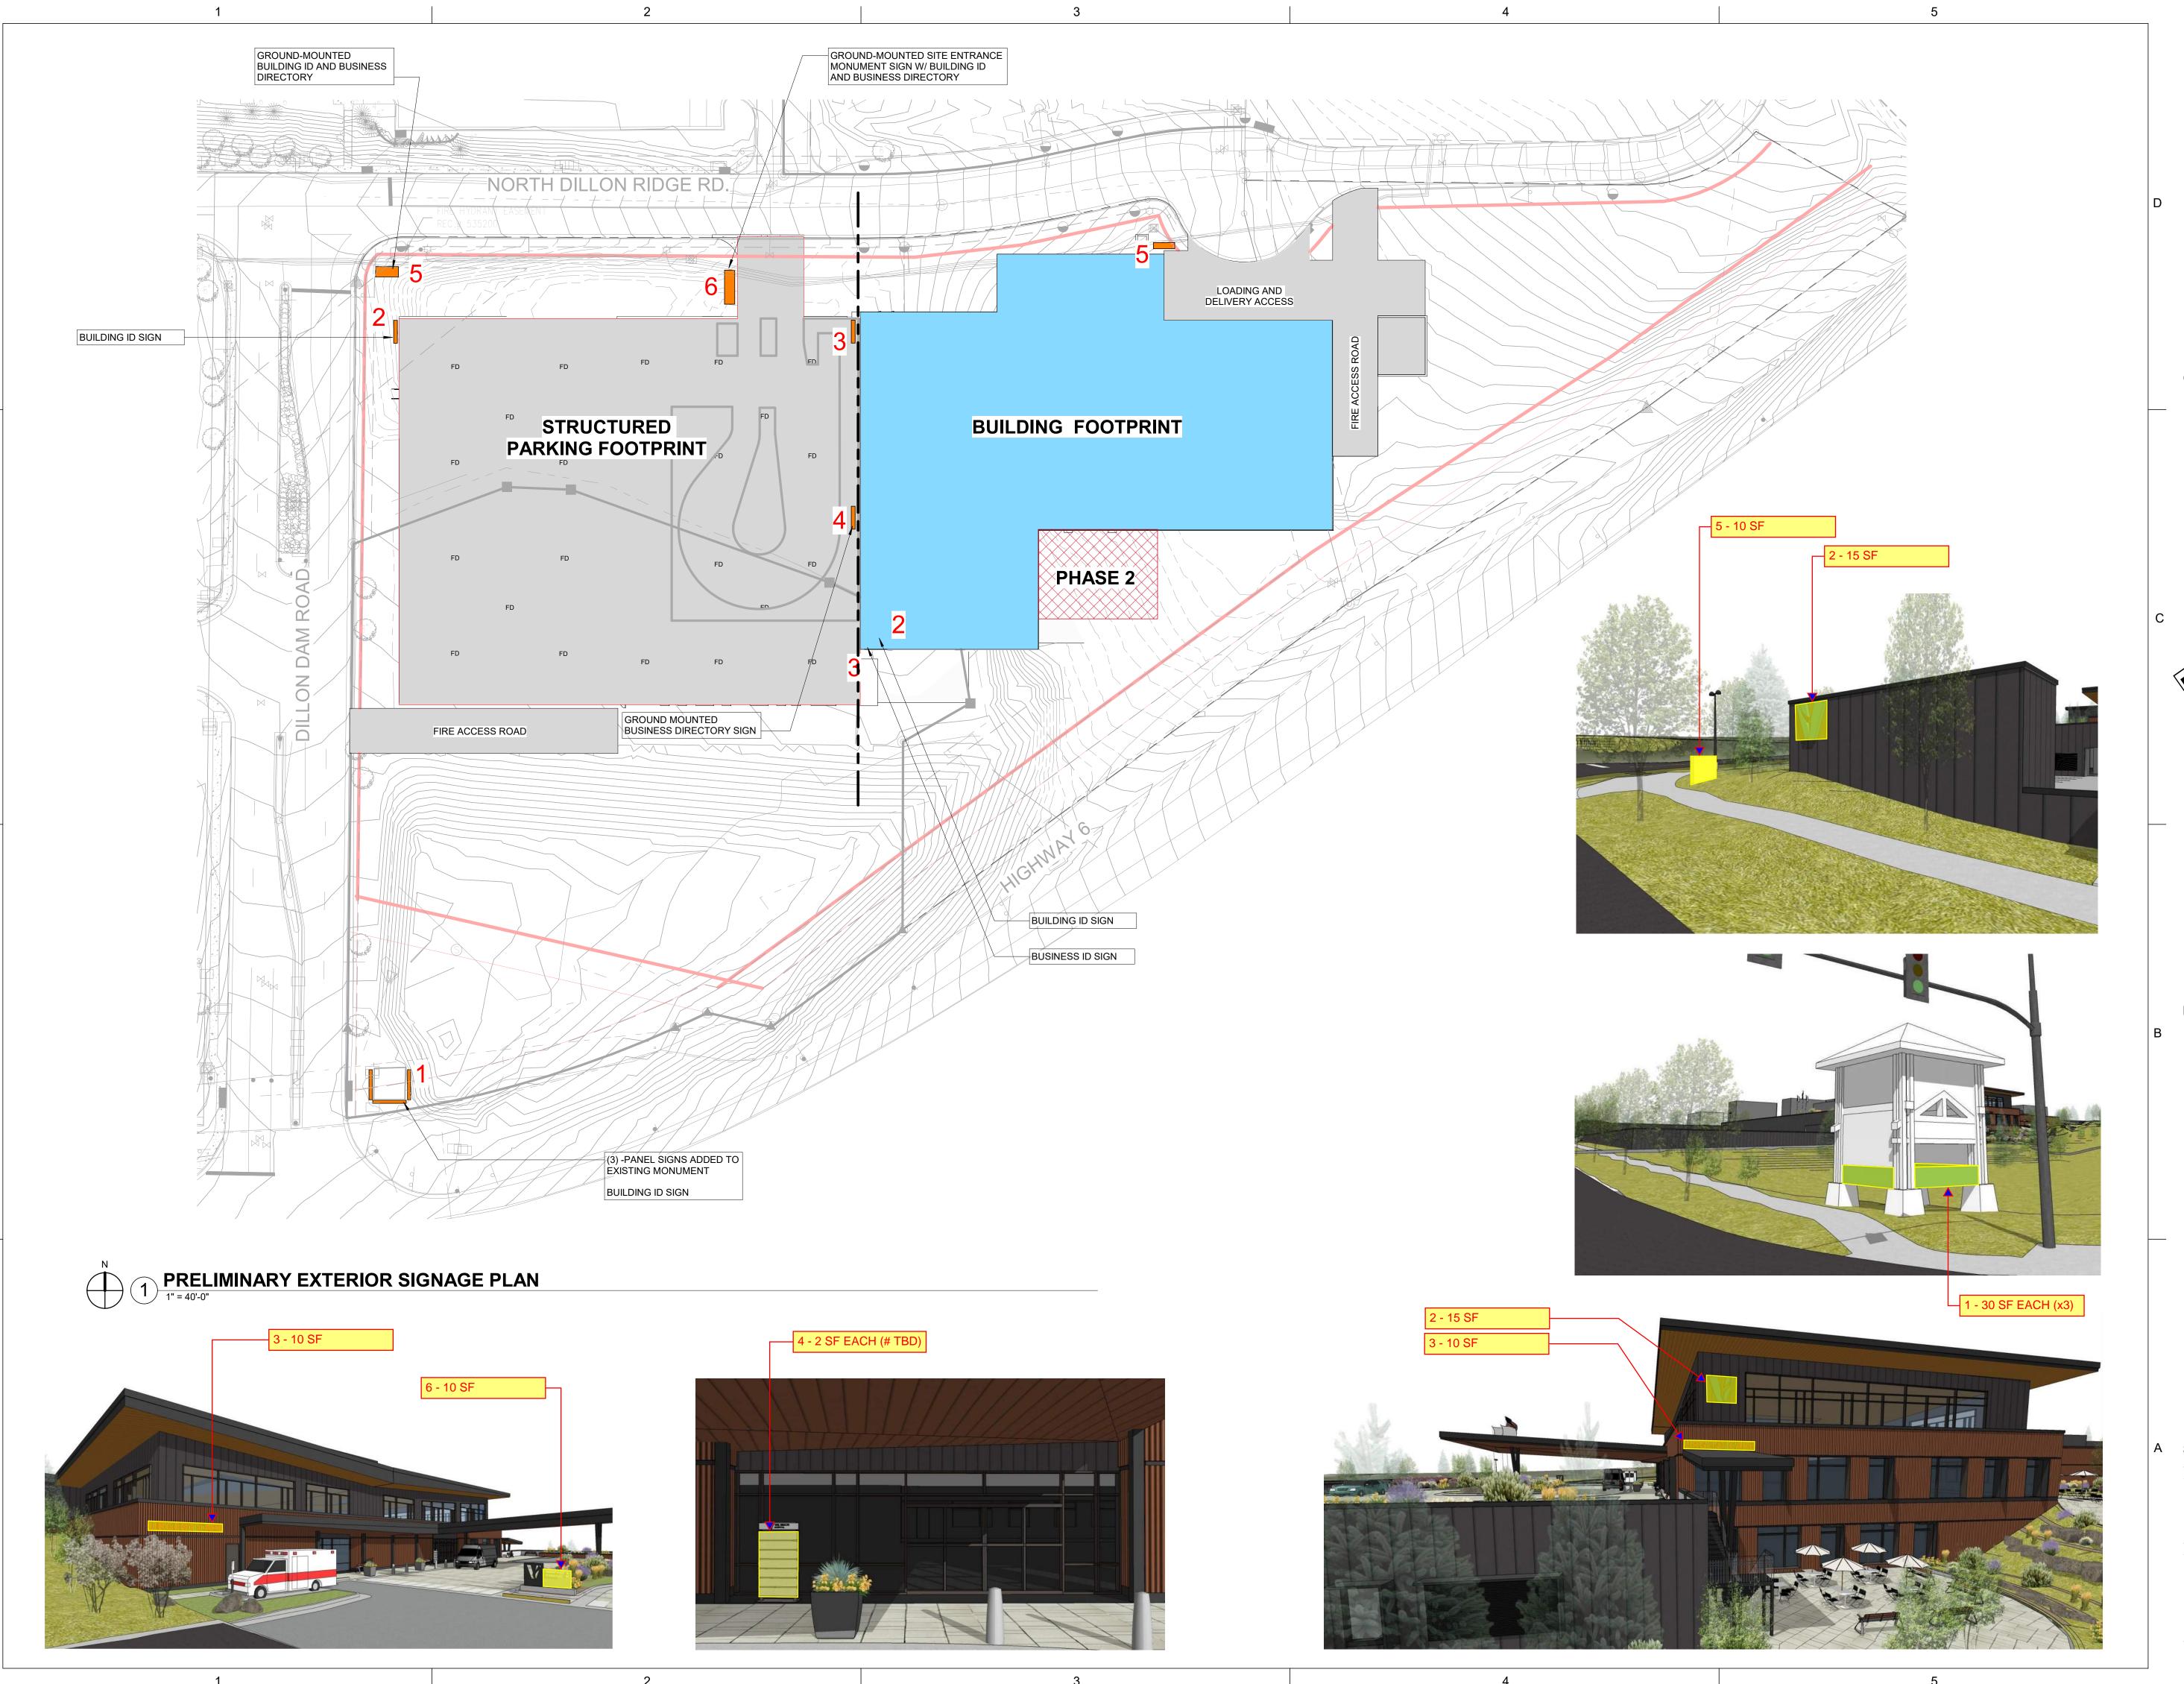

DAVIS
PARTNERSHIP
ARCHITECTS

DENVER OFFICE
2901 Blake Street, Suite 100
Denver, CO 80205
303.861.8555

Consultant

PROGRESS PRINTS

PROGRESS PRINTS

CONSTRUCTION

CONSTRUCTOR

CONSTRUCTOR

CON 1/23/2019 6:35:15 PM

Original Issuance Date

PUD DEVELOPMENT 07/23/2019
PLAN - REVISED

Revisions Date No.

roio at Information

Project Information

VAIL HEALTH - DILLON MEDICAL BUILDING DILLON, COLORADO 80435

Sheet Information

Sheet Title:
PRELIMINARY
SIGNAGE PLAN

Sheet Number:

A-11

From: Chris Holzwart

To: Ned West; Dan Burroughs
Cc: Adam Harding; Brian Berryhill

Subject: Town of Dillon: Design Guidelines Review: Vail Health - Dillon Medical Building, 19-0729

Date: Monday, July 29, 2019 12:19:21 PM

Attachments: <u>Attachments.html</u>

Importance: High

Hi Ned and Dan -

As the Design Guidelines Review consultant for Town of Dillon, please see our position below for the Vail Health – Dillon Medical Building:

RSA reviewed the current 'Dillon MOB_PUD Submittal' design and associated Design Guidelines application documents (Materials Board, Precedents, etc.) for the Vail Health – Dillon Medical Building project. See download links below for all reviewed materials.

Position

The current design for the Vail Health – Dillon Medical Building achieves the intent of the Design Guidelines. The design successfully utilized a strong connection with the ground, appropriate base/middle/top proportions, simple roof forms, punched openings in deep wall assemblies, muted palette of materials, concealment of utilities, and many of both 'Mountain-style' and 'Lake-style' principles established within the Design Guidelines.

Reviewed checklists of Design Standards

• See download link for "TownofDillon_DesignGuidelinesChecklistReview_VailHealthMOB_17 0729.pdf" for a review of the design relative to each Design Standard.

Reviewed Materials Board

 See download link for "VH Dillon – Materials Board_2019_07_23_RSAReview 19-0729.pdf" for markups of proposed materials.

We believe this concludes our participation as Design Guidelines Review consultant for the 'Vail Health – Dillon Medical Building'. We will await to hear from the Town of Dillon if we are requested to review any additional materials or revisions. Please let me know if you have any questions.

Citrix Attachments Exp	pires January 25, 2020
DILLON MOB_CONCEPT DESIGN_2019_06_07.pdf	11.3 MB
DILLON MOB_PUD Submittal_2019_07_23ced.pdf	19.2 MB
TownofDillon_DesignGuidelinesChecklistRe729.pdf	286.6 KB
VH Dillon - Materials Board_2019_07_23_R729.pdf	473.2 KB

699.7 KB

Download Attachments

Chris Holzwart uses Citrix Files to share documents securely.

Thanks,

CHRIS HOLZWART, RA, NCARB, LEED® AP

ROTH SHEPPARD ARCHITECTS, LLP

1900 WAZEE STREET, SUITE 100 | DENVER, COLORADO 80202 T:303.534.7007 F:303.534.7722 | www.rothsheppard.com

2012 AIA WESTERN MOUNTAIN REGION FIRM OF THE YEAR



2 CHARACTER & ENVIRONMENT

DESIGN STANDARDS CHECKLIST

VAIL HEALTH - DILLON, MEDICAL BUILDING: P&Z ARCH REVIEW: 7/29/19

·			
SECTION	APPLICANT Y/N	P&Z Y/N	P&Z COMMENTS
DRAW AUTHENTICITY FROM HISTORIC ARCHITECTU	JRE		
Symbolic connection to historic architecture		Υ	
DEFINE THE PUBLIC DOMAIN			
2-story datum at buildings taller than 2 stories		Y	
Building base use(s) meets intent of acceptable uses		Y	
Base height relates to 2-story datum, where possible		Y	
15' floor-to-floor height at grade level		Y	
Window sills no higher than 36"		Υ	
Storefront mullion colors to be dark (other finishes approved on a case-by-case basis)		Y	
Glazing meets or exceeds 60% transparent/40% solid ratio at <u>primary façade</u> base		N/A	ACCEPTED SPECIAL CONSIDERATION DUE TO BUILDING PROGRAM
Simply detailed storefront design		Y	STOREFRONT MULLION DESIGN @ ONCOLOGY & CMM CREATES A FINER GRAINED TEXTURE & CHARACER
Roofs/awnings designed for snowmelt mitigation		Y	
Fabric awning slope 1:3		N/A	
Permanent awning slope 3:12		N/A	ACCEPTED SPECIAL CONSIDERATION DUE TO BUILDING SCALE
Primary façade to have main building entrance		Υ	
(2) primary façades for buildings with (3) façades visible from public right-of-way		Y	
Façade materials should wrap corners a min. of 24"		Υ	
Blank walls visible to the public are not acceptable		Υ	
CREATE COMPLEMENTARY DEVELOPMENTS			
National brands adoption of these Guidelines for exterior architectural design		Y	
TAKE ADVANTAGE OF THE CLIMATE			
Conceal rooftop utilities from sight		Y	

March 2017 23



3 BUILDING FORM & ARTICULATION

DESIGN STANDARDS CHECKLIST

VAIL HEALTH - DILLON, MEDICAL BUILDING: P&Z ARCH REVIEW: 7/29/19

SECTION APPLICANT YN P8.Z YN P8.Z COMMENTS EXPRESS THE BASE, MIDDLE, & TOP Articulate building façades into Base, Middle, & Top Description of Base, Middle, & Top in Design Narrative No overly complex roofs or incompatible roof styles Use of proportional rules for Base, Middle, & Top EXPRESS THE BUILDING WEIGHT & STRUCTURE Description of contextual influence emphasis relative to apparent weight: Mountain or Lake BUILDING HEIGHTS & VIEW CORRIDORS Modulate façades above 2-story datum to differentiate from building base EXPRESS THE ROOF FORM Emphasize Top layer that caps building volumes below Y 5:12 minimum, and 12:12 maximum roof slope (steeper is acceptable if Jewel building) 3:12 min. roof slope for projections/permanent awnings N/A No mansard-style roof forms Simple, powerful, character-defining roof(s) Dormers set in a consistent rhythm, set 3' back from eave edge or projecting past eave edge Shed and gable roofs: 24" min. roof overhang at secondary façades, 18" min. roof overhang at primary façades, 18" min. roof overhang at secondary façades Use of structural beams, outriggers, and/or brackets at 18"+ roof overhangs. 2"x2" minimum dimension for exposed support ends CREATE RECESSES & PROJECTIONS Live of projections to project building entrances.	WHETERETT BILLOTT, WEBTONE BOILDING : 1 42	 	
Articulate building façades into Base, Middle, & Top Description of Base, Middle, & Top in Design Narrative No overly complex roofs or incompatible roof styles Use of proportional rules for Base, Middle, & Top EXPRESS THE BUILDING WEIGHT & STRUCTURE Description of contextual influence emphasis relative to apparent weight: Mountain or Lake BUILDING HEIGHTS & VIEW CORRIDORS Modulate façades above 2-story datum to differentiate from building base EXPRESS THE ROOF FORM Emphasize Top layer that caps building volumes below 5:12 minimum, and 12:12 maximum roof slope (steeper is acceptable if Jewel building) 3:12 min. roof slope for projections/permanent awnings N/A No mansard-style roof forms Simple, powerful, character-defining roof(s) Dormers set in a consistent rhythm, set 3' back from eave edge or projecting past eave edge Shed and gable roofs: 24" min. roof overhang at primary façades, 18" min. roof overhang at secondary façades, 18" min. roof overhang at secondary façades Roof runoff mitigation plan CREATE RECESSES & PROJECTIONS	SECTION		
Description of Base, Middle, & Top in Design Narrative No overly complex roofs or incompatible roof styles Use of proportional rules for Base, Middle, & Top EXPRESS THE BUILDING WEIGHT & STRUCTURE Description of contextual influence emphasis relative to apparent weight: Mountain or Lake BUILDING HEIGHTS & VIEW CORRIDORS Modulate façades above 2-story datum to differentiate from building base EXPRESS THE ROOF FORM Emphasize Top layer that caps building volumes below 5:12 minimum, and 12:12 maximum roof slope (steeper is acceptable if Jewel building) 3:12 min. roof slope for projections/permanent awnings N/A No mansard-style roof forms Simple, powerful, character-defining roof(s) Domners set in a consistent rhythm, set 3' back from eave edge or projecting past eave edge Shed and gable roofs: 24" min. roof overhang at primary façades, 18" min. roof overhang at secondary façades, 18" min. roof overhang at secondary façades Use of structural beams, outriggers, and/or brackets at 18"+ roof overhangs. 2"x2" minimum dimension for exposed support ends Roof runoff mitigation plan CREATE RECESSES & PROJECTIONS	EXPRESS THE BASE, MIDDLE, & TOP		
No overly complex roofs or incompatible roof styles Use of proportional rules for Base, Middle, & Top EXPRESS THE BUILDING WEIGHT & STRUCTURE Description of contextual influence emphasis relative to apparent weight: Mountain or Lake BUILDING HEIGHTS & VIEW CORRIDORS Modulate façades above 2-story datum to differentiate from building base EXPRESS THE ROOF FORM Emphasize Top layer that caps building volumes below 5:12 minimum, and 12:12 maximum roof slope (steeper is acceptable if Jewel building) 3:12 min. roof slope for projections/permanent awnings N/A No mansard-style roof forms Simple, powerful, character-defining roof(s) Domners set in a consistent rhythm, set 3' back from eave edge or projecting past eave edge Shed and gable roofs: 24" min. roof overhang at primary façades, 18" min. roof overhang at secondary façades Use of structural beams, outriggers, and/or brackets at 18"+ roof overhangs. 2"x2" minimum dimension for expossed support ends Roof runoff mitigation plan CREATE RECESSES & PROJECTIONS	Articulate building façades into Base, Middle, & Top	Υ	
Use of proportional rules for Base, Middle, & Top EXPRESS THE BUILDING WEIGHT & STRUCTURE Description of contextual influence emphasis relative to apparent weight: Mountain or Lake BUILDING HEIGHTS & VIEW CORRIDORS Modulate façades above 2-story datum to differentiate from building base EXPRESS THE ROOF FORM Emphasize Top layer that caps building volumes below 5:12 minimum, and 12:12 maximum roof slope (steeper is acceptable if Jewel building) 3:12 min. roof slope for projections/permanent awnings N/A No mansard-style roof forms Simple, powerful, character-defining roof(s) Domers set in a consistent rhythm, set 3' back from eave edge or projecting past eave edge Shed and gable roofs: 24" min. roof overhang at primary façades, 18" min. roof overhang at primary façades, 18" min. roof overhang at secondary façades Use of structural beams, outriggers, and/or brackets at 18"+ roof overhangs. 2"x2" minimum dimension for expossed support ends Roof runoff mitigation plan CREATE RECESSES & PROJECTIONS	Description of Base, Middle, & Top in Design Narrative	N	NO NARRATIVE PROVIDED
EXPRESS THE BUILDING WEIGHT & STRUCTURE Description of contextual influence emphasis relative to apparent weight: Mountain or Lake BUILDING HEIGHTS & VIEW CORRIDORS Modulate façades above 2-story datum to differentiate from building base EXPRESS THE ROOF FORM Emphasize Top layer that caps building volumes below 5:12 minimum, and 12:12 maximum roof slope (steeper is acceptable if Jewel building) 3:12 min. roof slope for projections/permanent awnings N/A No mansard-style roof forms Simple, powerful, character-defining roof(s) Dormers set in a consistent rhythm, set 3' back from eave edge or projecting past eave edge Shed and gable roofs: 24" min. roof overhang at primary façades, 18" min. roof overhang at secondary façades Use of structural beams, outriggers, and/or brackets at 18"+ roof overhangs. 2"x2" minimum dimension for exposed support ends Roof runoff mitigation plan CREATE RECESSES & PROJECTIONS	No overly complex roofs or incompatible roof styles	Υ	
Description of contextual influence emphasis relative to apparent weight: Mountain or Lake BUILDING HEIGHTS & VIEW CORRIDORS Modulate façades above 2-story datum to differentiate from building base EXPRESS THE ROOF FORM Emphasize Top layer that caps building volumes below 5:12 minimum, and 12:12 maximum roof slope (steeper is acceptable if Jewel building) 3:12 min. roof slope for projections/permanent awnings N/A No mansard-style roof forms Simple, powerful, character-defining roof(s) Domners set in a consistent rhythm, set 3' back from eave edge or projecting past eave edge Shed and gable roofs: 24" min. roof overhang at primary façades, 18" min. roof overhang at secondary façades Use of structural beams, outriggers, and/or brackets at 18"+ roof overhangs. 2"x2" minimum dimension for exposed support ends Roof runoff mitigation plan Y RUNOFF COLLECTED WA INTERNAL ROOF DRAMS CREATE RECESSES & PROJECTIONS	Use of proportional rules for Base, Middle, & Top	Y	
relative to apparent weight: Mountain or Lake BUILDING HEIGHTS & VIEW CORRIDORS Modulate façades above 2-story datum to differentiate from building base EXPRESS THE ROOF FORM Emphasize Top layer that caps building volumes below 5:12 minimum, and 12:12 maximum roof slope (steeper is acceptable if Jewel building) 3:12 min. roof slope for projections/permanent awnings N/A No mansard-style roof forms Simple, powerful, character-defining roof(s) Dormers set in a consistent rhythm, set 3' back from eave edge or projecting past eave edge Shed and gable roofs: 24" min. roof overhang at primary façades, 18" min. roof overhang at secondary façades Use of structural beams, outriggers, and/or brackets at 18"+ roof overhangs. 2"x2" minimum dimension for exposed support ends Roof runoff mitigation plan CREATE RECESSES & PROJECTIONS	EXPRESS THE BUILDING WEIGHT & STRUCTURE	<u>'</u>	
Modulate façades above 2-story datum to differentiate from building base EXPRESS THE ROOF FORM Emphasize Top layer that caps building volumes below 5:12 minimum, and 12:12 maximum roof slope (steeper is acceptable if Jewel building) 3:12 min. roof slope for projections/permanent awnings N/A No mansard-style roof forms Y Simple, powerful, character-defining roof(s) Domers set in a consistent rhythm, set 3' back from eave edge or projecting past eave edge Shed and gable roofs: 24" min. roof overhang at primary façades, 18" min. roof overhang at secondary façades Use of structural beams, outriggers, and/or brackets at 18"+ roof overhangs. 2"x2" minimum dimension for exposed support ends Roof runoff mitigation plan CREATE RECESSES & PROJECTIONS	· ·	Y	
differentiate from building base EXPRESS THE ROOF FORM Emphasize Top layer that caps building volumes below 5:12 minimum, and 12:12 maximum roof slope (steeper is acceptable if Jewel building) 3:12 min. roof slope for projections/permanent awnings N/A No mansard-style roof forms Simple, powerful, character-defining roof(s) Domers set in a consistent rhythm, set 3' back from eave edge or projecting past eave edge Shed and gable roofs: 24" min. roof overhang at primary façades, 18" min. roof overhang at secondary façades Use of structural beams, outriggers, and/or brackets at 18"+ roof overhangs. 2"x2" minimum dimension for exposed support ends Roof runoff mitigation plan CREATE RECESSES & PROJECTIONS	BUILDING HEIGHTS & VIEW CORRIDORS		
Emphasize Top layer that caps building volumes below 5:12 minimum, and 12:12 maximum roof slope (steeper is acceptable if Jewel building) 3:12 min. roof slope for projections/permanent awnings N/A No mansard-style roof forms Y Simple, powerful, character-defining roof(s) Dormers set in a consistent rhythm, set 3' back from eave edge or projecting past eave edge Shed and gable roofs: 24" min. roof overhang at primary façades, 18" min. roof overhang at secondary façades Use of structural beams, outriggers, and/or brackets at 18"+ roof overhangs. 2"x2" minimum dimension for exposed support ends Roof runoff mitigation plan Y NOT NECESSARLY A JEWEL BUILDING (SEE DEFINITIONS DUE TO USE AND LOCATION Y N/A N/A N/A RUNOFF COLLECTED VIA INTERNAL ROOF DRAINS CREATE RECESSES & PROJECTIONS	·	Y	
5:12 minimum, and 12:12 maximum roof slope (steeper is acceptable if Jewel building) 3:12 min. roof slope for projections/permanent awnings N/A No mansard-style roof forms N/A Nomers set in a consistent rhythm, set 3' back from eave edge or projecting past eave edge Shed and gable roofs: 24" min. roof overhang at primary façades, 18" min. roof overhang at 18"+ roof overhangs. 2"x2" minimum dimension for exposed support ends Roof runoff mitigation plan Y not recessarily a Jewel BuilDing (SEE DEFINITIONS), But a BuilDing (SEE DeFinition), But a BuilDing (SEE DEFINITIONS), But a BuilDing (SEE DEFINITIONS), But a BuilDing (SEE DEFINITIONS), But a BuilDing (SEE DeFinition), But a BuilDing (SEE DeFinition), But a BuilDing (SEE DEFINITIONS), But a BuilDing (SEE DEFINITIONS), But a BuilDing (See DeFinition), But a B	EXPRESS THE ROOF FORM		
is acceptable if Jewel building) 3:12 min. roof slope for projections/permanent awnings N/A No mansard-style roof forms Simple, powerful, character-defining roof(s) Dormers set in a consistent rhythm, set 3' back from eave edge or projecting past eave edge Shed and gable roofs: 24" min. roof overhang at primary façades, 18" min. roof overhang at secondary façades Use of structural beams, outriggers, and/or brackets at 18"+ roof overhangs. 2"x2" minimum dimension for exposed support ends Roof runoff mitigation plan Y RUNOFF COLLECTED VIA INTERNAL ROOF DRAINS CREATE RECESSES & PROJECTIONS	Emphasize Top layer that caps building volumes below	Y	
No mansard-style roof forms Simple, powerful, character-defining roof(s) Dormers set in a consistent rhythm, set 3' back from eave edge or projecting past eave edge Shed and gable roofs: 24" min. roof overhang at primary façades, 18" min. roof overhang at secondary façades Use of structural beams, outriggers, and/or brackets at 18"+ roof overhangs. 2"x2" minimum dimension for exposed support ends Roof runoff mitigation plan Y RUNOFF COLLECTED VIA INTERNAL ROOF DRAINS CREATE RECESSES & PROJECTIONS	, , ,	Υ	DEFINITIONS), BUT A BUILDING REQUIRING SPECIAL
Simple, powerful, character-defining roof(s) Dormers set in a consistent rhythm, set 3' back from eave edge or projecting past eave edge Shed and gable roofs: 24" min. roof overhang at primary façades, 18" min. roof overhang at secondary façades Use of structural beams, outriggers, and/or brackets at 18"+ roof overhangs. 2"x2" minimum dimension for exposed support ends Roof runoff mitigation plan Y RUNOFF COLLECTED VIA INTERNAL ROOF DRAINS CREATE RECESSES & PROJECTIONS	3:12 min. roof slope for projections/permanent awnings	N/A	
Dormers set in a consistent rhythm, set 3' back from eave edge or projecting past eave edge Shed and gable roofs: 24" min. roof overhang at primary façades, 18" min. roof overhang at secondary façades Use of structural beams, outriggers, and/or brackets at 18"+ roof overhangs. 2"x2" minimum dimension for exposed support ends Roof runoff mitigation plan Y RUNOFF COLLECTED VIA INTERNAL ROOF DRAINS CREATE RECESSES & PROJECTIONS	No mansard-style roof forms	Υ	
eave edge or projecting past eave edge Shed and gable roofs: 24" min. roof overhang at primary façades, 18" min. roof overhang at secondary façades Use of structural beams, outriggers, and/or brackets at 18"+ roof overhangs. 2"x2" minimum dimension for exposed support ends Roof runoff mitigation plan Y RUNOFF COLLECTED VIA INTERNAL ROOF DRAINS CREATE RECESSES & PROJECTIONS	Simple, powerful, character-defining roof(s)	Υ	
at primary façades, 18" min. roof overhang at secondary façades Use of structural beams, outriggers, and/or brackets at 18"+ roof overhangs. 2"x2" minimum dimension for exposed support ends Roof runoff mitigation plan Y RUNOFF COLLECTED VIA INTERNAL ROOF DRAINS CREATE RECESSES & PROJECTIONS	•	Y	
at 18"+ roof overhangs. 2"x2" minimum dimension for exposed support ends Roof runoff mitigation plan CREATE RECESSES & PROJECTIONS	at primary façades, 18" min. roof overhang at	Y	
CREATE RECESSES & PROJECTIONS	at 18"+ roof overhangs. 2"x2" minimum dimension for	N/A	
	Roof runoff mitigation plan	Υ	RUNOFF COLLECTED VIA INTERNAL ROOF DRAINS
Use of projections to protect building entrances	CREATE RECESSES & PROJECTIONS		
ose of brojections to brotect boliding entitations	Use of projections to protect building entrances	Y	
Concealed drainage at projections Y	Concealed drainage at projections	Υ	

March 2017 36



4 CRAFT, MATERIALS, & COLORS

DESIGN STANDARDS CHECKLIST

VAIL HEALTH - DILLON, MEDICAL BUILDING : P&Z ARCH REVIEW : 7/29/19

VAIL FILALITY DILLON, MILDICAL BOILDING . F &Z			<i>57</i> 1 <i>6</i>
SECTION	APPLICANT Y/N	P&Z Y/N	P&Z COMMENTS
HIGHLIGHT THE CRAFT			
Utilize or mimic authentic fastening and joinery methods		Υ	ENOURAGE REFERENCE TO HISTORIC PRECEDENTS AND/OR FEATURES FOR NEXT REVIEW
Pragmatic and highly crafted architectural features		Υ	SIMPLE CLEAN LINES
USE LOCAL MATERIALS & TEXTURES			
Minimum of (2) primary façade materials		Υ	ACCEPTED CONSIDERATION OF (2) METALS DUE TO NATURAL WEATHERING STEEL AS A BASE MATERIAL AND LARGER-SCALED METAL OF DIFF. COLOR ABOVE
Stone heights min. 4"H, with preference for 8-12"H		N/A	
Materials wrap building corners min. of 24"		N/A	
Ashlar pattern at stone cladding		N/A	
Rough-sawn or hand-hewn finish at timbers		N/A	
Use of acceptable wood cladding patterns		Υ	CURRENTLY STACKED PLANK PATTERN OF ALUMINUM SOFFIT (WOOD LOOK)
Use of metal cladding for roof and/or wall accent only		Υ	SEE PRIMARY FACADE MTL'S COMMENT ABOVE
Use of acceptable metal wall and/or roof patterns		Y	
Clear glazing ratio of 60% min. glazing to 40% solid		Y	ACCEPTED SPECIAL CONSIDERATION DUE TO BUILDING PROGRAM AND LOCATION
Clear glazing with no more than 10% light reduction. No opaque films or glass at <u>public domain</u> .		Y	CONSIDER LIGHT SPILLAGE @ NORTH WINDOWS FACING RESIDENTIAL AREAS
Stucco at building Middle layer, not Base layer		N/A	
COLOR PALETTES & ACCENTS			
Darker tone storefront mullion color		Υ	
Natural color palette with combination of marine accents (if Lake style influences)		N/A	NEUTRAL COLOR PALETTE SATISFIES INTENT OF GUIDELINE, EVEN THOUGH BOTH MOUNTAIN AND LAKESTYLE FEATURES ARE EMPLOYED
Façade colors of medium to dark natural tones. Bright colors only used for interventions or minor focal elements.		Y	
Roof colors of dark natural tones (unless galvanized), muted, low reflectivity, natural tones. Bright colors only used for interventions or minor focal elements.		Y	
10% maximum area usable for accent colors on façades		Y	

March 2017 46


P&Z ARCH REVIEW: 7/29/19



ALUMINIM FRAMES COLOR: DARK BRONZE



ALUMINUM SOFFIT PANEL COLOR: WOOD LOOK, ACCENT COLOR

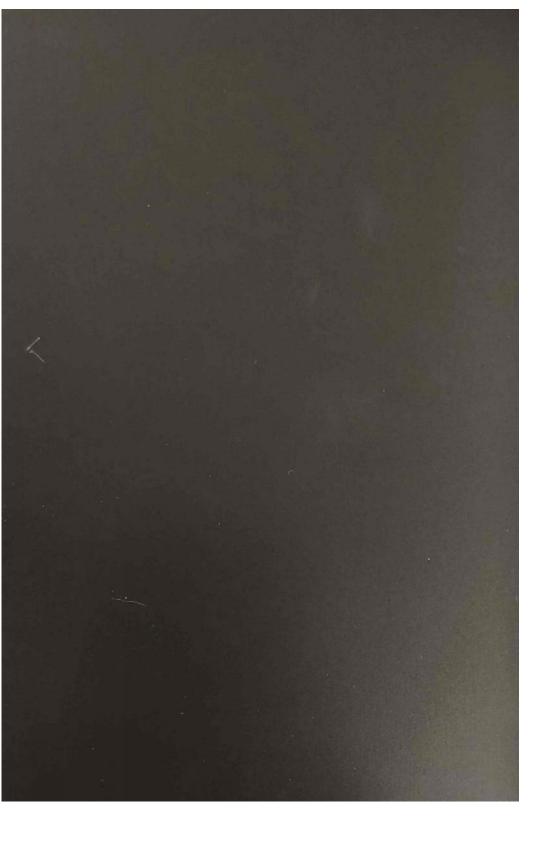

FORMED METAL PANEL AND FASCIAS COLOR: DARK BRONZE




CORRUGATED METAL PANEL COLOR: NATURAL WEATHERING



PRECAST CONCRETE COLOR: CUSTOM COLOR/MIX TO MATCH METAL PANEL AND FACIAS

MATERIAL SAMPLES

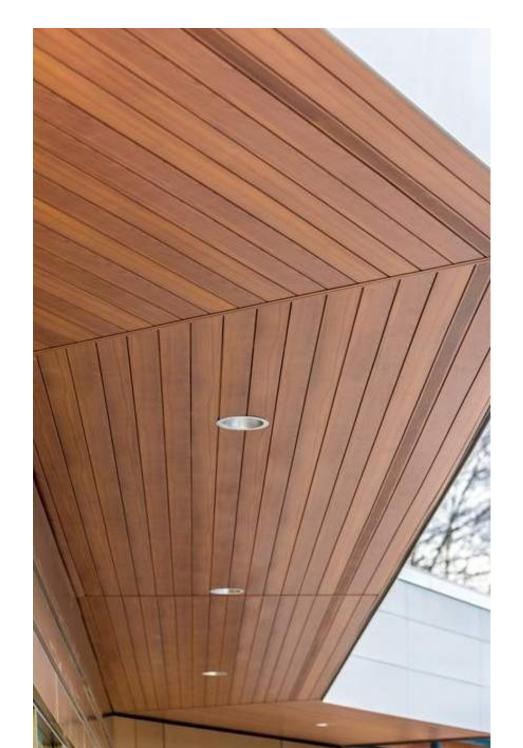







INSTALLATION EXAMPLES





VAIL HEALTH - DILLON MEDICAL BUILDING MATERIALS BOARD

RESOLUTION NO. PZ 16-19 Series of 2019

A RESOLUTION APPROVING FINAL ARCHITECTURAL PLANS FOR THE DILLON MEDICAL BUILDING PUD DEVELOPMENT PLAN.

WHEREAS, Ten Mile Holdings, LLC (the "**Developer**") has received Town Council approval, with conditions, pursuant to Ordinance No. 01-19, Series of 2019, to develop the Dillon Medical Building PUD Development Plan ("**PUD Plan**") at the property located on Block 12R Dillon Ridge Marketplace Replat E, Town of Dillon, County of Summit, State of Colorado; and

WHEREAS, pursuant to paragraph 2 of Exhibit B to Ordinance No. 01-19, Series of 2019, the Developer is required to submit final architectural design and renderings ("Final Architectural Plans") for review and approval by the Town of Dillon Planning and Zoning Commission ("Planning Commission") in a public hearing; and

WHEREAS, the Town has received the Final Architectural Plans from the Applicant, and the Town's architectural consultant has found the Final Architectural Plans to achieve the intent of the Town's Design Guidelines; and

WHEREAS, following the required notice, a public hearing on the Final Architectural Plans was held on August 7, 2019 before the Planning Commission; and

WHEREAS, following the public hearing the Planning Commission has made certain findings of fact regarding the Final Architectural Plans and has determined that certain conditions which are reasonable and necessary to and relate to impacts created by the development should attach to the approval of the Final Architectural Plans.

NOW, THEREFORE, BE IT RESOLVED BY THE PLANNING AND ZONING COMMISSION OF THE TOWN OF DILLON, COLORADO, AS FOLLOWS:

Section 1. The Planning Commission, following the required notice, held a public hearing on August 7, 2019 to review the Final Architectural Plans submitted by the Applicant, and following said public hearing makes the following findings of fact:

- A. That the Applicant has submitted Final Architectural Plans for review by Town staff and the Town's architectural consultant, and has presented the Final Architectural Plans to the Planning Commission in a public hearing.
- B. That the Final Architectural Plans comply with the Design Guidelines set forth in Chapter 16, Article VIII of the Dillon Municipal Code.
- C. That the Applicant has satisfied the condition set forth in paragraph 2 of Exhibit B to Ordinance No. 01-19, Series of 2019.

<u>Section 2</u>. The Planning Commission hereby approves the Final Architectural Plans for the Dillon Medical Building PUD Development Plan, subject to the following conditions:

- A. That the remaining conditions of approval set forth in Exhibit B to Ordinance No. 01-19, Series of 2019, shall be satisfied by the Applicant.
- B. That the Final Plans hereby approved shall be incorporated by the Applicant into the Dillon Medical Building PUD Development Plan prior to the issuance of a Building Permit for the development.

APPROVED AND ADOPTED THIS 7^{th} DAY OF AUGUST, 2019 BY THE PLANNING AND ZONING COMMISSION OF THE TOWN OF DILLON, COLORADO.

PLANNING AND ZONING COMMISSION, TOWN OF DILLON

ATTEST:	By: Teresa England, Chairperson
By: Kelly Stevens, Secretary to	

7/30/19 2:53 PM [ncb] R:\Dillon\Subdivision\Vail Health\Approving Architectural Plans.reso.docx